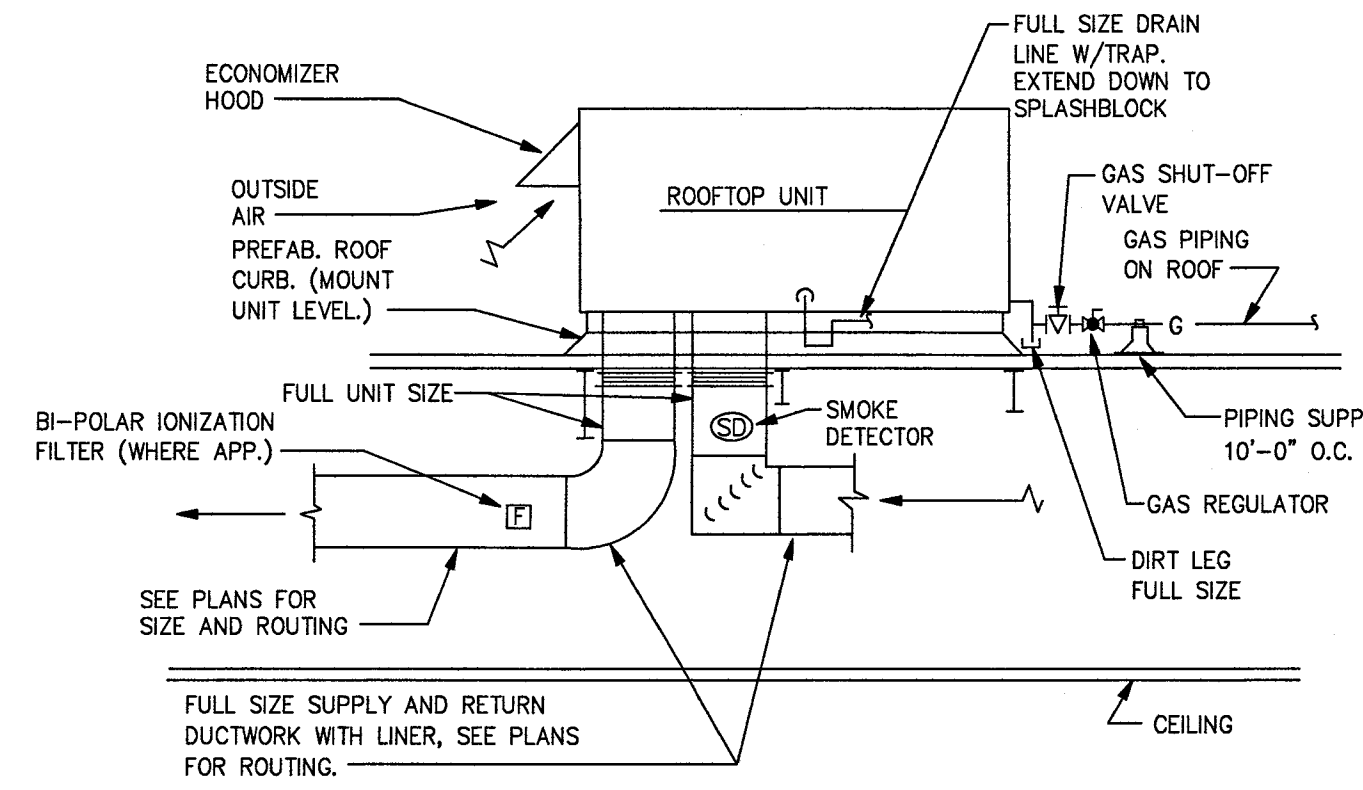
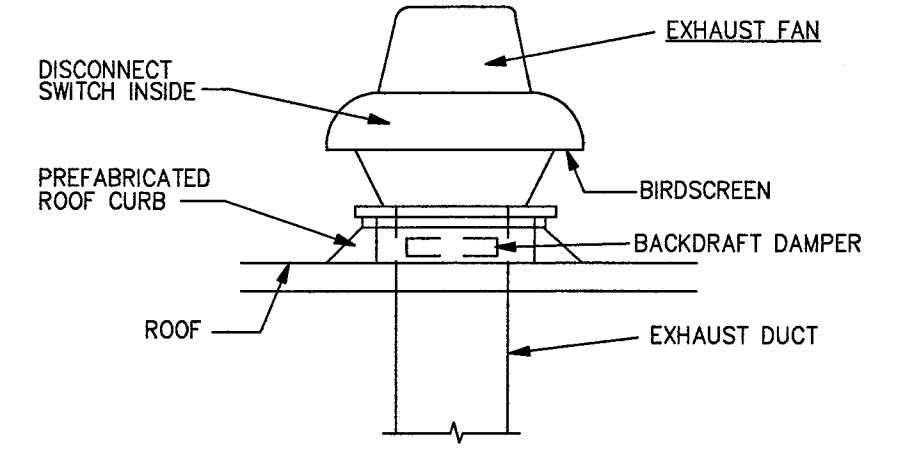



- NOTES:
 1. PROVIDE OPENING IN ROOF SIZED FOR SUPPLY AND RETURN DUCTS. ALL OTHER AREAS UNDER UNIT SHALL HAVE ANGLES AND SHEET METAL ACROSS UNDER UNIT WITH BATT INSULATION FILLING VOID.
 2. ROOF CURBS SHALL MATCH SLOPE OF ROOF.
 3. SMOKE DETECTORS SHALL BE IONIZATION TYPE WIRED TO SHUT DOWN THE UNIT UPON ACTIVATION. SMOKE DETECTORS SHALL BE PROVIDED AND WIRED BY THE ELECTRICAL CONTRACTOR AND INSTALLED IN THE DUCT BY THE MECHANICAL CONTRACTOR.




1 GAS-FIRED ROOFTOP UNIT DETAIL
 SCALE: NONE



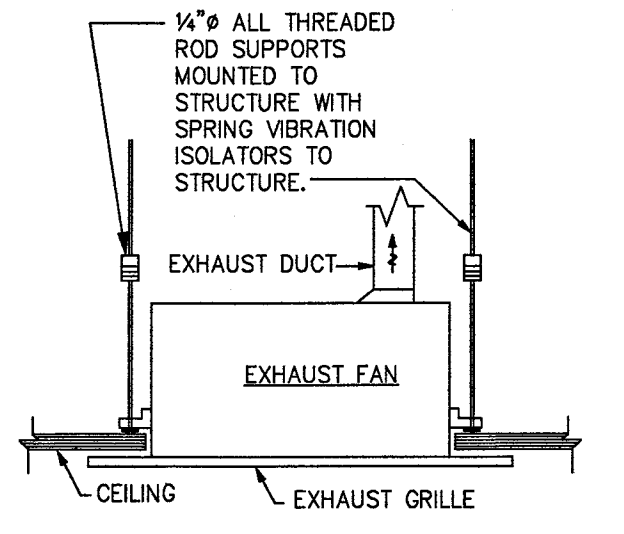
2 ROOF-MOUNTED EXHAUST FAN DETAIL
 SCALE: NONE



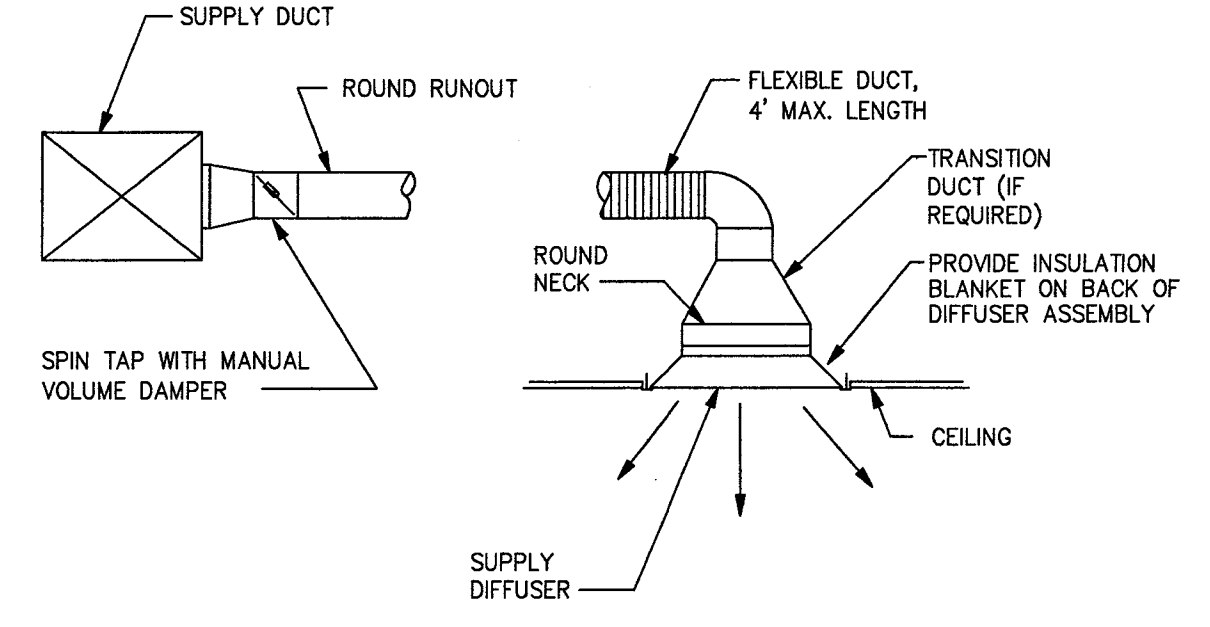
3 CEILING MOUNTED FAN DETAIL
 SCALE: NONE



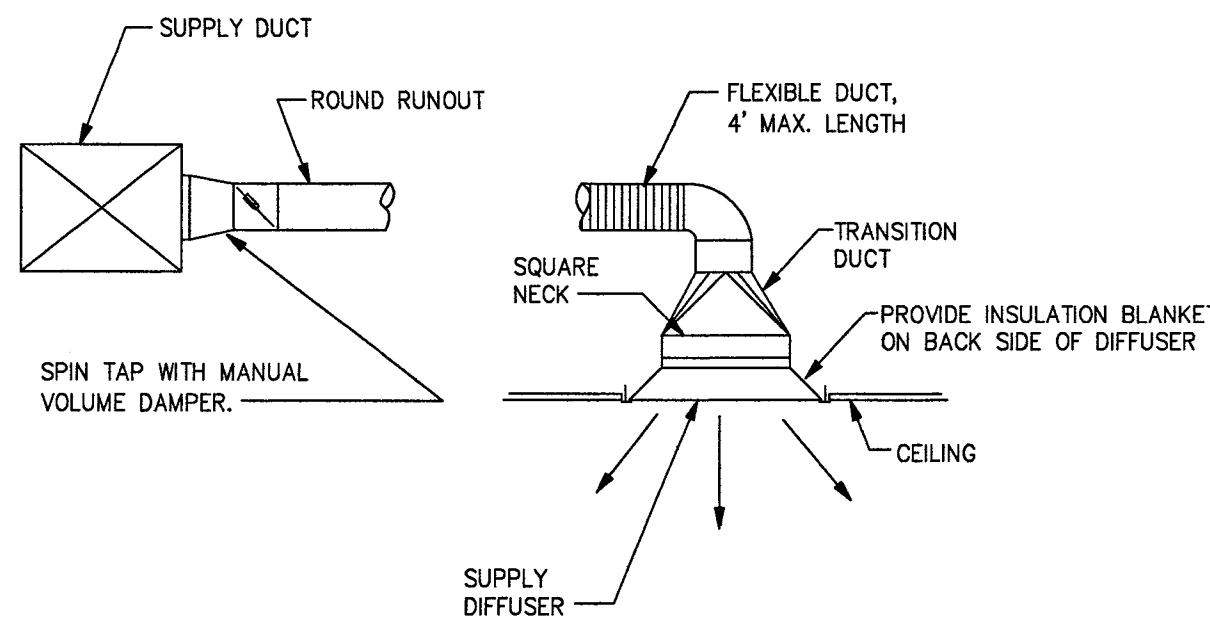4 SPIN TAP TO ROUND NECK DIFFUSER
 SCALE: NONE



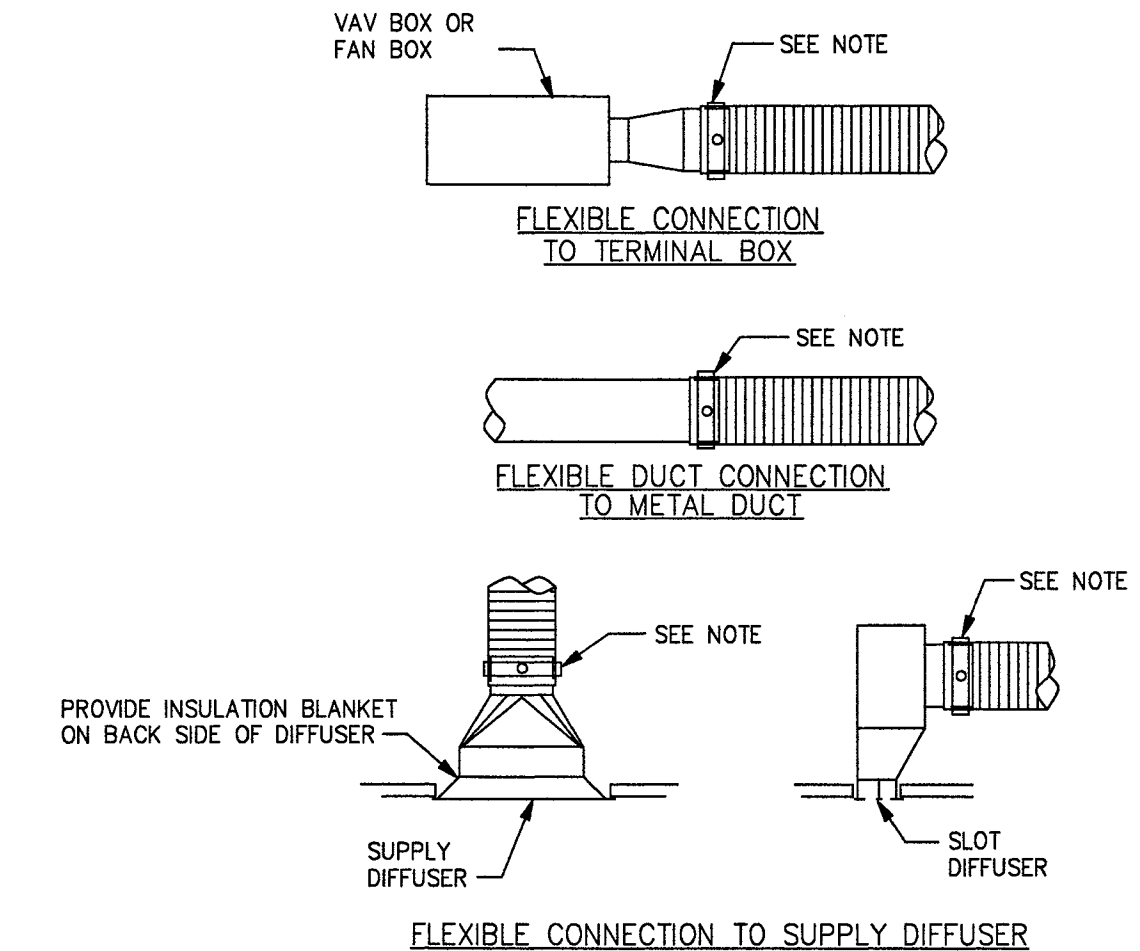5 SPIN TAP TO SQUARE NECK DIFFUSER
 SCALE: NONE



6 TYPICAL FLEX. CONNECTION DETAILS
 SCALE: NONE

NOTE: ALL FLEXIBLE DUCT CONNECTIONS TO SHEET METAL SHALL BE SECURED WITH NYLON STRAP AND 2 SHEET METAL SCREWS (MIN.).

PlasmaSoft

Ay Caramba 1 - Restaurant Seating

PlasmaSoft calculations are exclusively for Plasma Air products and should not be used for any other manufacturers.

ASHRAE 62.1
 Space Contaminant Calculations Using Appendix D Equations

USER INPUT FIELDS

Green colored fields need user input. Yellow colored fields are constants provided by Plasma Air. Pink fields are auto-calculated based on user selection. Grey values are auto-calculated but also editable.

ASHRAE Equation: Equation 5 - Filter return air and outside air, Constant Volume Supply Air, Constant Volume Outside Air

Space Type: Restaurant dining rooms
 Area (Sq Ft.): 1705
 Number of People: 155
 Supply Air (CFM): 655
 Emission Rate/ Person (µg/min): 150

Calculation of Space Contaminants Using Ventilation Rate Procedure (VRP) OA

Variable	Description	Value	Units
N	Contaminant Generation Rate	0.560	µg/min
Ex	Zone Air Distribution Effectiveness	0.8	
Voa	Outdoor Air Flow Rate	2,282.26	L/min
EF	Filter Efficiency	0.98	
Ce	Contaminant Concentration, OA	0.2	µg/m³
R	Recirculation Flow Variable = Vx/(Vx+Vr)	0.37	
Vr	Return Air Flow Rate	6,502.54	L/min
Cbz	Contaminant Concentration, zone	0.286	µg/m

Is the Cbz for the IAQP equal or less than Cbz for the VRP? **NO**

PlasmaSoft

Ay Caramba 1 - Bar Area

PlasmaSoft calculations are exclusively for Plasma Air products and should not be used for any other manufacturers.

ASHRAE 62.1
 Space Contaminant Calculations Using Appendix D Equations

USER INPUT FIELDS

Green colored fields need user input. Yellow colored fields are constants provided by Plasma Air. Pink fields are auto-calculated based on user selection. Grey values are auto-calculated but also editable.


ASHRAE Equation: Equation 5 - Filter return air and outside air, Constant Volume Supply Air, Constant Volume Outside Air

Space Type: Bar, cocktail lounge
 Area (Sq Ft.): 655
 Number of People: 52
 Supply Air (CFM): 655
 Emission Rate/ Person (µg/min): 150

Calculation of Space Contaminants Using Ventilation Rate Procedure (VRP) OA


Variable	Description	Value	Units
N	Contaminant Generation Rate	0.771	µg/min
Ex	Zone Air Distribution Effectiveness	0.8	
Voa	Outdoor Air Flow Rate	6,758.78	L/min
EF	Filter Efficiency	0.98	
Ce	Contaminant Concentration, OA	0.2	µg/m³
R	Recirculation Flow Variable = Vx/(Vx+Vr)	0.47	
Vr	Return Air Flow Rate	6,048.22	L/min
Cbz	Contaminant Concentration, zone	0.330	µg/m

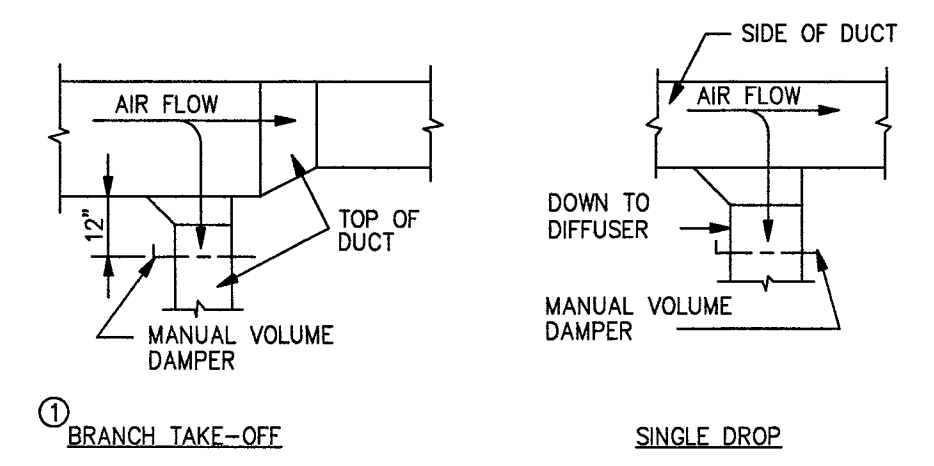Is the Cbz for the IAQP equal or less than Cbz for the VRP? **NO**



7 DUCTWORK DETAIL
 SCALE: NONE

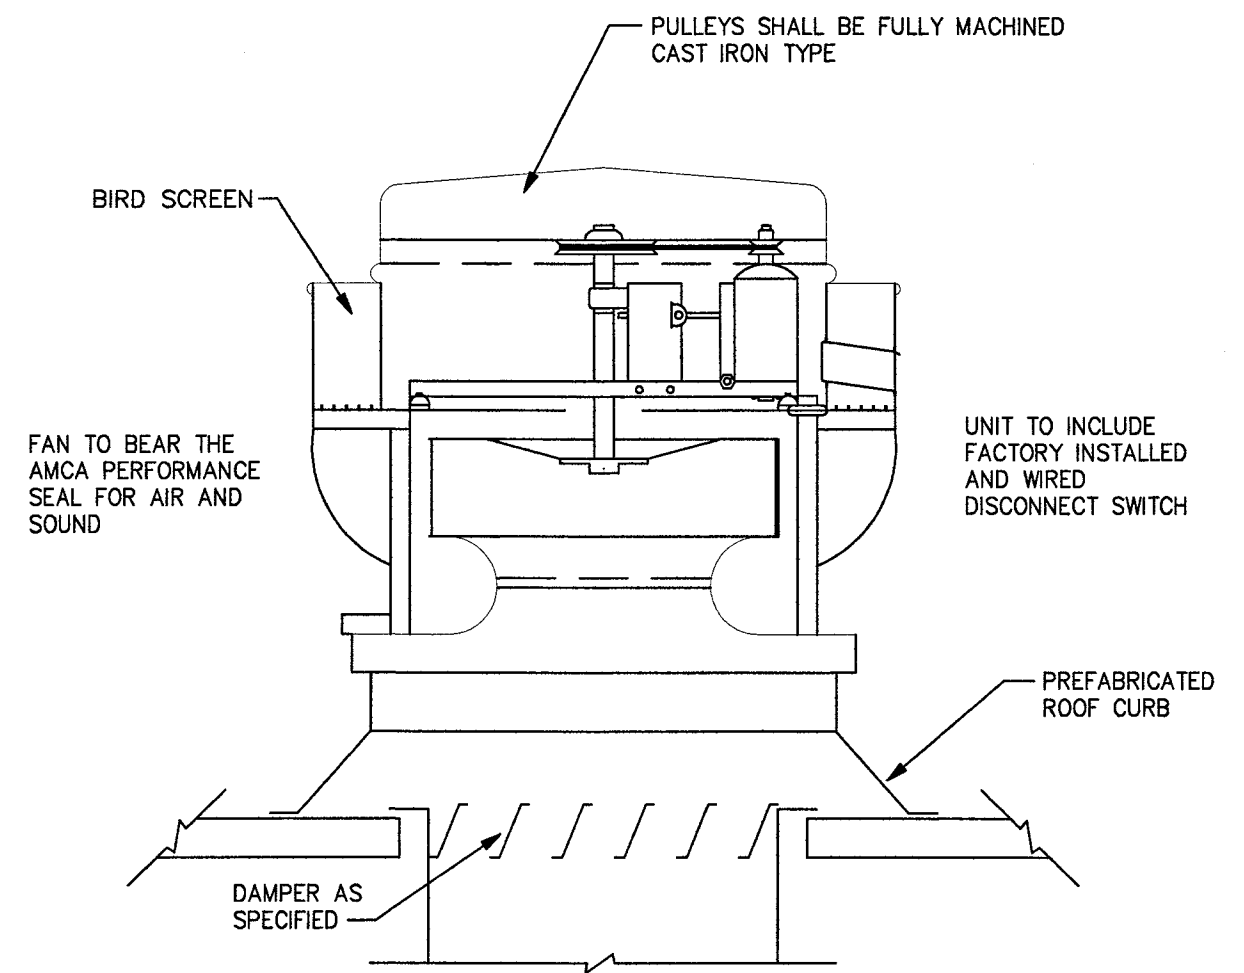NOTE:
 1. USE BRANCH TAKE-OFF ① WHEN MAIN AND BRANCH DUCTS ARE DIFFERENT DEPTHS
 2. USE BRANCH TAKE-OFF ② WHEN MAIN AND BRANCH DUCTS ARE SAME DEPTHS



8 CENTRIFUGAL UPBLAST ROOF EXHAUST FAN
 SCALE: NONE

NOTE:
 FANS HANDLING GREASE LADEN AIR SHALL BE PROVIDED WITH GREASE DRIP TRAYS/GUTTERS AND HINGED FAN ACCESS. GREASE GUTTER SHALL DRAIN TO A COLLECTION CONTAINER. CONTAINER SHALL BE DRAINED AS PART OF MAINTENANCE SCHEDULE BASED ON THE COLLECTION RATE AND SIZE OF THE CONTAINER.

dh&a


ARCHITECTURE, PA

1208 CURTIS STREET
 MONROE, NORTH CAROLINA 28112, TELE: 704-283-2408
 FAX: 704-291-7909
 cha.architects@frontier.com

CONSULTANTS



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 P-1817
 1001 LANCASTER AVE.
 MONROE, NC 28112
 704-282-0826

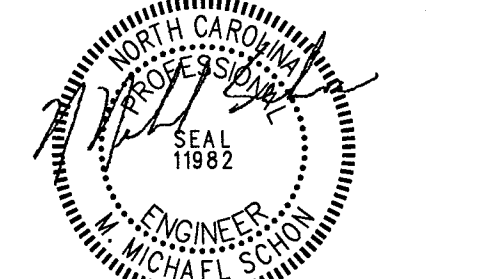

12/20/22

RESTAURANT AT CARAMBA 1


650 WEST ROOSEVELT BLVD.
 MONROE, NC 28110

MARK	DATE	DESCRIPTION
ISSUE:	08/29/2022	
PROJECT NO:	22159	
CAD DWG FILE:	SEE DRAWINGS	
DRAWN BY:	MMS	
CHECKED BY:	MMS	

SHEET TITLE

MECHANICAL DETAILS

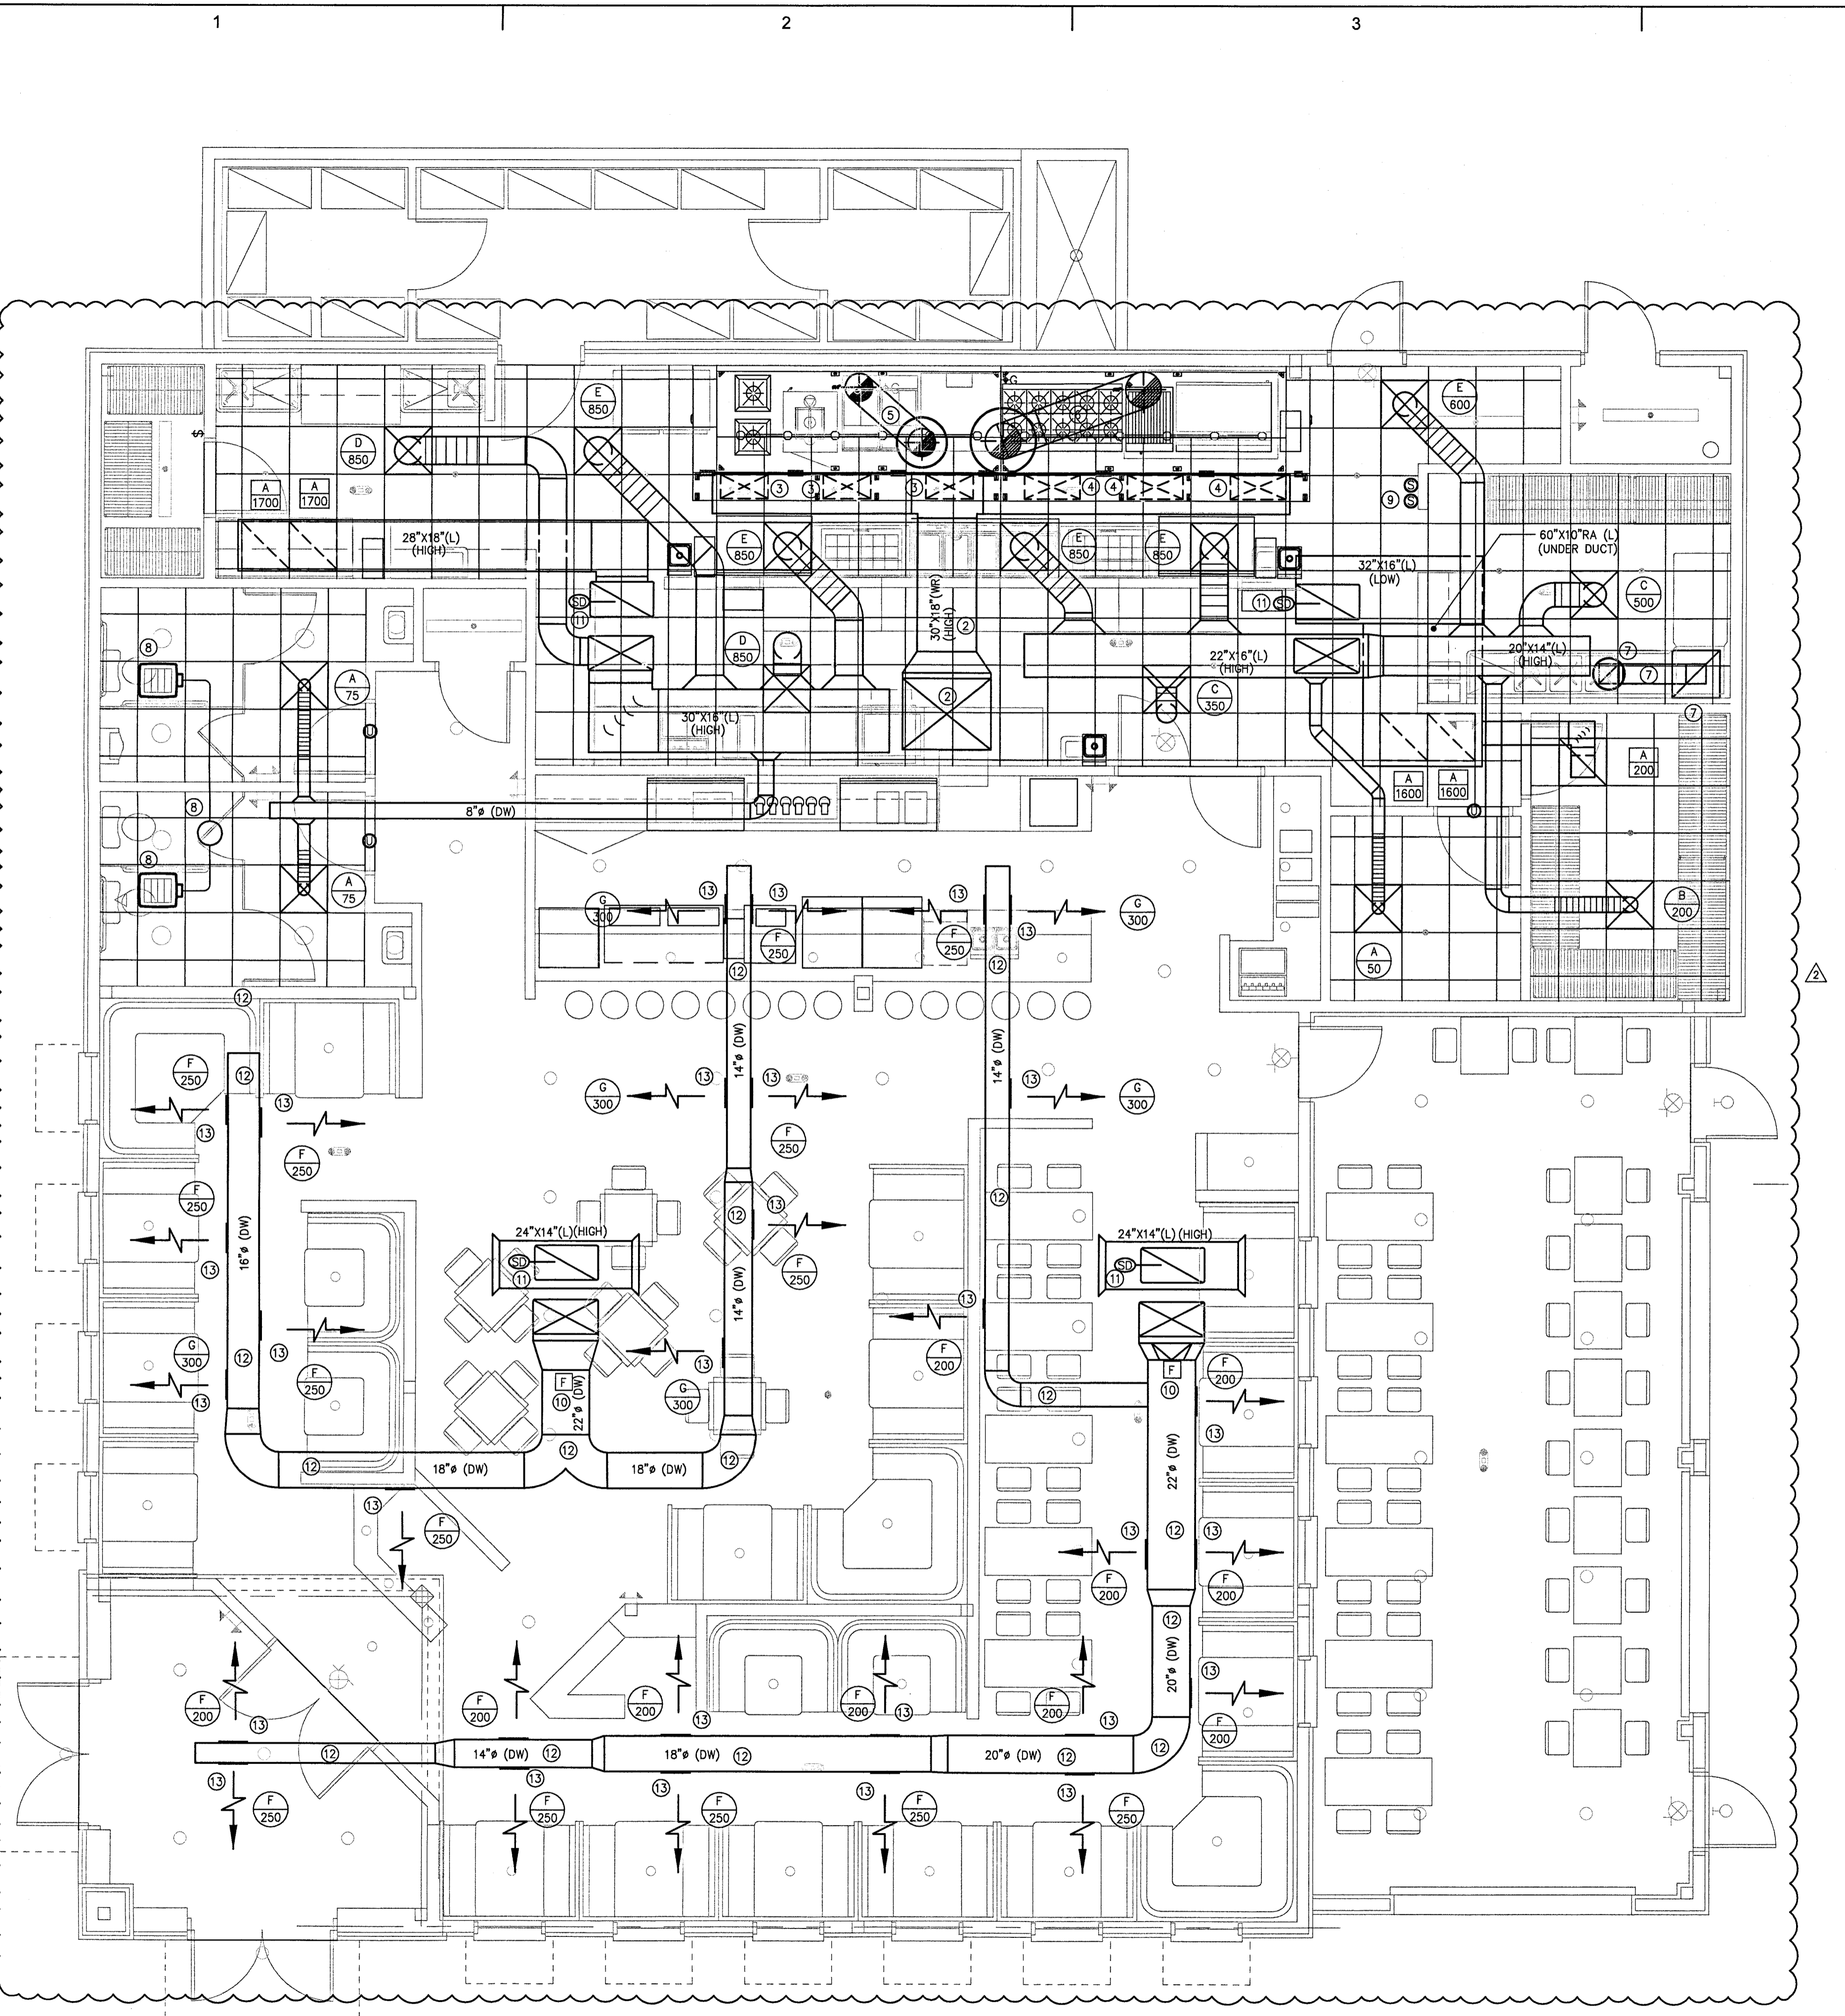M0.3



NOTES THIS SHEET

- ① SEE SHEETS M0.1 - M0.3 FOR SCHEDULES, DETAILS AND SPECIFICATIONS.
- ② NEW 30"x18" SA FROM MUJ-1 UNIT, TRANSITION TO UNIT CONNECTION SIZE AS REQUIRED. ROUTE NEW DUCT TO 20"x18" MAU DUCT THAT PROVIDES AIR TO THE SA PLENUM AT HOOD.
- ③ 24"x12" MUA CONNECTION FROM 20"x18" MUA DUCT TO CONNECTION AT HOOD, TYPICAL OF THREE, BALANCE AIR TO 636 CFM EACH. PROVIDE MANUAL BALANCING DAMPER AT HOOD CONNECTION.
- ④ 28"x12" MUA CONNECTION FROM 20"x18" MUA DUCT TO CONNECTION AT HOOD, TYPICAL OF THREE, BALANCE AIR TO 720 CFM EACH. PROVIDE MANUAL BALANCING DAMPER AT HOOD CONNECTION.
- ⑤ 14" GREASE DUCT (16 GAUGE, CARBON STEEL, WELDED CONTINUOUSLY). TIE INTO CONNECTION AT HOOD AND ROUTE AS INDICATED TO KITCHEN HOOD EXHAUST FAN, KEF-1. PROVIDE 2 LAYERS OF FIRE MASTER INSULATION WHERE THE EXHAUST DUCT IS CLOSER THAN 18" TO COMBUSTIBLES. PROVIDE UL LISTED CLEANOUTS AT ALL 90 DEGREE ELBOWS AND EVERY 20 FEET OF LENGTH. FIELD VERIFY EXACT LOCATION/CONDITIONS.
- ⑥ 18" GREASE DUCT (16 GAUGE, CARBON STEEL, WELDED CONTINUOUSLY). TIE INTO CONNECTION AT HOOD AND ROUTE AS INDICATED TO KITCHEN HOOD EXHAUST FAN, KEF-2. PROVIDE 2 LAYERS OF FIRE MASTER INSULATION WHERE THE EXHAUST DUCT IS CLOSER THAN 18" TO COMBUSTIBLES. PROVIDE UL LISTED CLEANOUTS AT ALL 90 DEGREE ELBOWS AND EVERY 20 FEET OF LENGTH. FIELD VERIFY EXACT LOCATION/CONDITIONS.
- ⑦ 10"x10" ALUMINUM DUCT FROM 2'X2'X12" ALUMINUM HOOD AT DISHWASHER. DUCT SHALL SLOPE BACK TOWARDS THE HOOD. DUCT SHALL BE CAULKED FOR WATERPROOF JOINTS. ROUTE TO ROOF MOUNTED EXHAUST FAN, EF-3.
- ⑧ CEILING EXHAUST FAN, EF-1, ROUTE 8" EXHAUST DUCT TO COMMON 10" EXHAUST DUCT THAT EXTENDS UP TO ROOF CAP. FIELD VERIFY EXACT LOCATION. MAINTAIN 10 FEET BETWEEN ANY EXHAUST TERMINATION AND OUTSIDE AIR INTAKE.
- ⑨ EMERGENCY SHUT DOWN BUTTON FOR KITCHEN HOOD, FIELD VERIFY EXACT LOCATION.
- ⑩ PROVIDE PLASMA FILTER, EQUAL TO PLASMA AIR 7000 SERIES IN SA DUCT MAIN. SEE CALCULATIONS ON SHEET M0.3.
- ⑪ PROVIDE EACH UNIT WITH A UL LISTED, SMOKE DETECTOR IN RETURN AIR DUCT MAIN TO SHUT UNIT DOWN UPON ACTIVATION. PROVIDE AND INSTALL REMOTE ANNUNCIATING DEVICE WITH A KEYPAD OVERRIDE, REMOTE ANNUNCIATING DEVICE SHALL BE LOCATED IN A ROUTINELY OCCUPIED AREA AND SHALL IDENTIFY ASSOCIATED EQUIPMENT IN ALARM.
- ⑫ SPIRAL DUCT SHALL BE DOUBLED WALL (DW). THE DUCT SHALL BE SUPPORTED FROM STRUCTURE WITH ALL THREAD RODS PER MANUFACTURER'S AND SMAGNA STANDARDS.
- ⑬ GRILLES IN THE SPIRAL DUCT SHALL BE MOUNTED AT 30 DEGREES DOWNWARD FROM HORIZONTAL.

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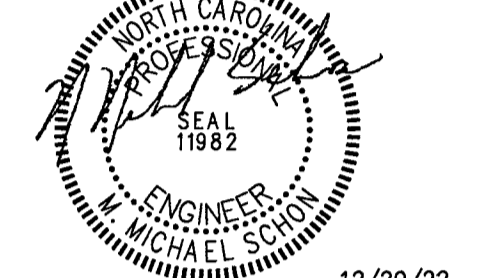
ARCHITECTURE, PA

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RESTAURANT
AT CARAMBA I

650 WEST ROOSEVELT BLVD.
MONROE, NC 28110


1 FLOOR PLAN - MECHANICAL
SCALE: 1/4" = 1'-0"

MARK	DATE	DESCRIPTION
Δ	12/20/22	OWNER VE CHANGES

SHEET TITLE

**FLOOR PLAN
MECHANICAL**

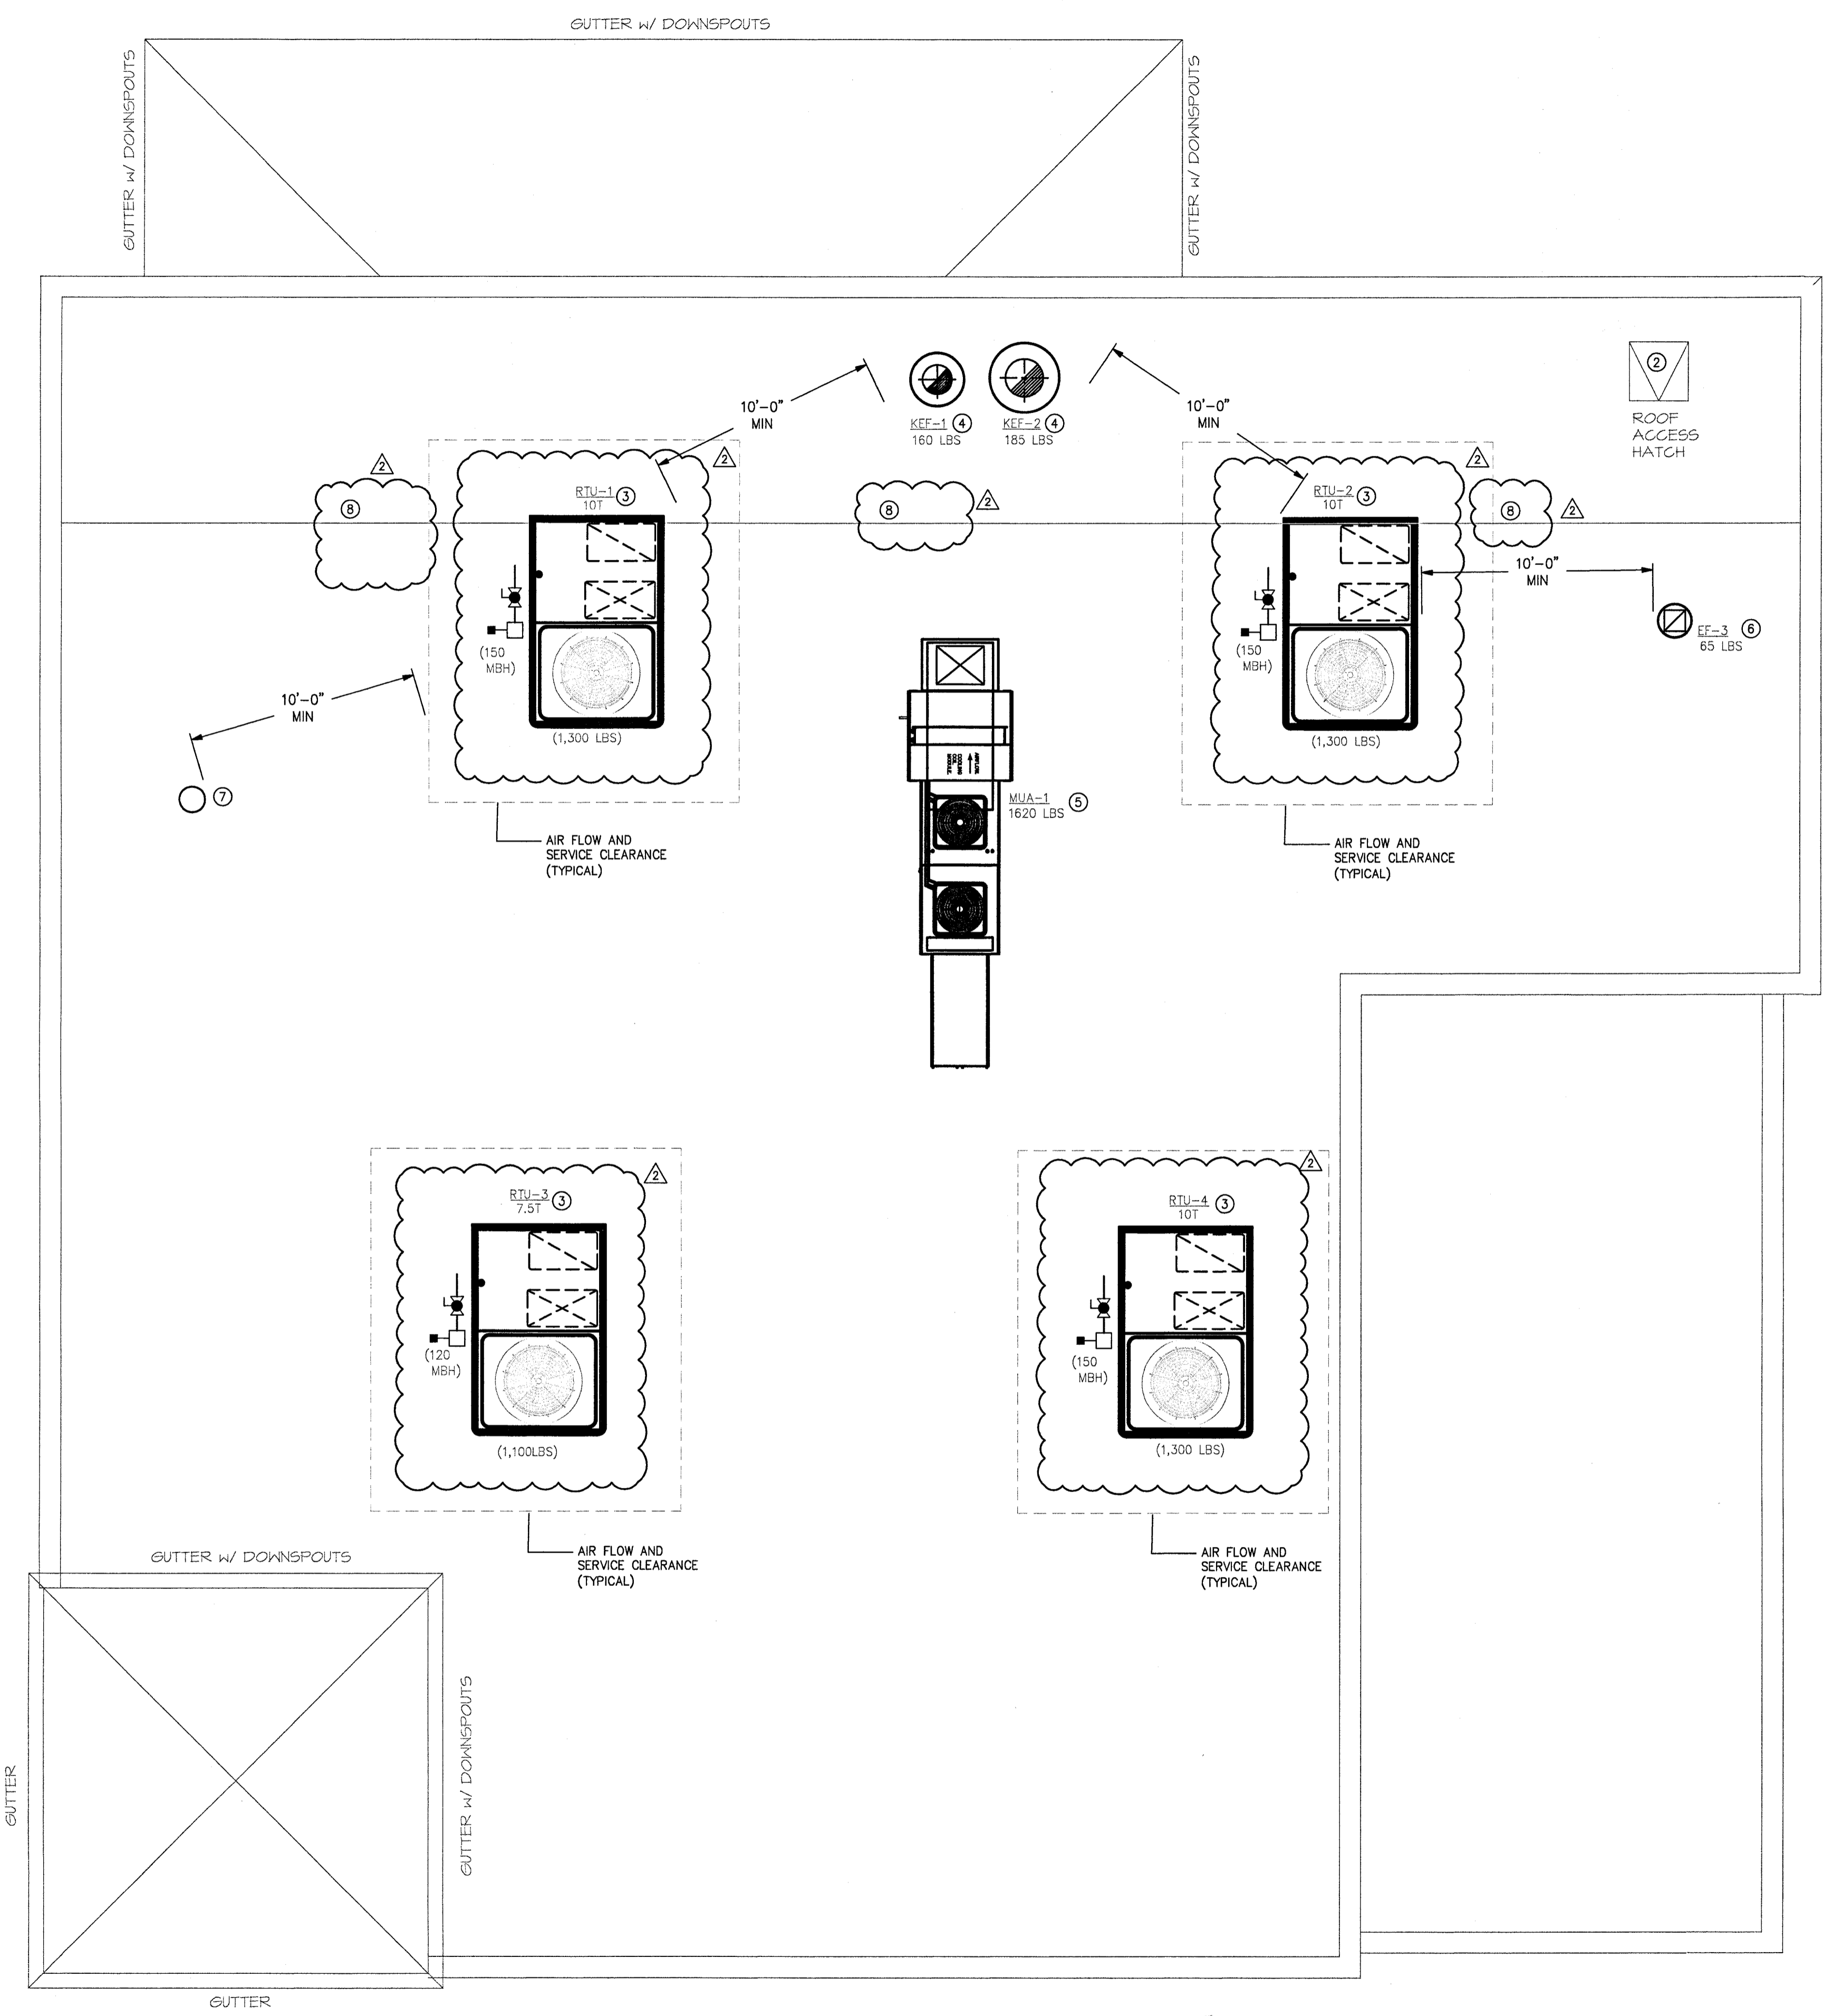M1.1



- NOTES THIS SHEET**
- ① SEE SHEETS M0.1 - M0.3 FOR SCHEDULES, DETAILS AND SPECIFICATIONS.
 - ② PERMANENT ROOF HATCH, ACCESSIBLE THRU MECHANICAL ROOM. FIELD VERIFY EXACT LOCATION.
 - ③ NEW ROOF TOP UNIT ON FACTORY ROOF CURB, FIELD VERIFY EXACT LOCATION WITH STRUCTURAL PLANS. PROVIDE EACH UNIT WITH A UL LISTED, SMOKE DETECTOR IN RETURN AIR DUCT MAIN TO SHUT UNIT DOWN UPON ACTIVATION. PROVIDE AND INSTALL REMOTE ANNUNCIATING DEVICE WITH A KEYED OVERRIDE. REMOTE ANNUNCIATING DEVICE SHALL BE LOCATED IN A ROUTINELY OCCUPIED AREA AND SHALL IDENTIFY ASSOCIATED EQUIPMENT IN ALARM.
 - ④ ROOF MOUNTED KITCHEN HOOD EXHAUST FANS, KEF-1 & KEF-2, ON FACTORY ROOF CURB. OFFSET HOOD EXHAUST DUCT AS INDICATED TO MAINTAIN 10 FEET BETWEEN EXHAUST AND ANY OA INTAKE AT THE UNITS. INTERLOCK HOOD EXHAUST FAN WITH MAKE-UP AIR UNIT, MUA-1 SO THAT THE MUA UNIT IS ENERGIZED WHEN THE EXHAUST FANS ARE ENERGIZED.
 - ⑤ MAKE-UP AIR UNIT, MUA-1, ON FACTORY ROOF CURB. COORDINATE EXACT LOCATION WITH STRUCTURAL DRAWINGS. MUA-1 UNIT SHALL BE INTERLOCKED WITH KITCHEN HOOD EXHAUST FANS TO ENERGIZE WHEN THE HOOD EXHAUST FANS ARE ENERGIZED.
 - ⑥ DISHWASHER HOOD FAN, EF-3, ON FACTORY ROOF CURB. FIELD VERIFY EXACT LOCATION.
 - ⑦ 10% EXHAUST DUCT FROM RESTROOM FANS, TERMINATING WITH FACTORY ROOF CAP, FIELD VERIFY EXACT LOCATION.
 - ⑧ ROOF DRAIN - DELETED

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**RESTAURANT
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650 WEST ROOSEVELT BLVD.
 MONROE, NC 28110

MARK	DATE	DESCRIPTION
△	12/20/22	OWNER VE CHANGES
ISSUE: 08/29/2022		
PROJECT NO: 22159		
CAD DWG FILE: SEE DRAWINGS		
DRAWN BY: MMS		
CHECKED BY: MMS		

SHEET TITLE

**ROOF PLAN
 MECHANICAL**

M2.1

1 **ROOF PLAN - MECHANICAL**
 SCALE: 1/4" = 1'-0"

FOR QUESTIONS, CALL THE
 CITY OF MONROE REGION 30
 PHONE: (704) 844-9088
 EMAIL: region30@monroenc.gov

PATENT NUMBERS
 AC-PSP (UNITED STATES) - US PATENT 7963830 B2.
 AC-PSP WALL (CANADA) - CA PATENT 2820509.
 AC-PSP ISLAND (CANADA) - CA PATENT 2520330.

HOOD INFORMATION - JOB#5574303

HOOD NO	TAG	MODEL	MANUFACTURER	LENGTH	MAX COOKING TEMP	TYPE	APPLIANCE DUTY	DESIGN CFM/FT	TOTAL EXH CFM	EXHAUST PLENUM RISER(S)				TOTAL SUPPLY CFM	HOOD CONSTRUCTION	HOOD CONFIG				
										WIDTH	LENG	HEIGHT	DIA			CFM	VEL	SP	END TO	ROW
1		5424 ND-2-PSP-F	CAPTIVEAIRE	12' 0"	450 DEG	I	MEDIUM	185	2220			4"	14"	2220	2077	-0.947"	1909	430 SS WHERE EXPOSED	LEFT	ALONE
2		5424 ND-2-PSP-F	CAPTIVEAIRE	12' 0"	600 DEG	I	HEAVY	240	2880			4"	18"	2880	1630	-0.876"	2160	430 SS WHERE EXPOSED	RIGHT	ALONE

HOOD INFORMATION

HOOD NO	TAG	TYPE	FILTER(S)		EFFICIENCY @ 7 MICRONS	QTY	LIGHT(S)		WIRE GUARD	LOCATION	SIZE	UTILITY CABINET(S)		ELECTRICAL MODEL #	SWITCHES QUANTITY	FIRE SYSTEM PIPING	HOOD HANGING WEIGHT
			QTY	HEIGHT			LENG	TYPE				SIZE	FIRE SYSTEM				
1		CAPTIVE SOLO FILTER	9	20"	16"	85% SEE FILTER SPEC	6	L55 SERIES E26	NO	LEFT	12"x54"x24"			SC-321110MA	1 LIGHT 1 FAN	YES	782 LBS
2		CAPTIVE SOLO FILTER	9	20"	16"	85% SEE FILTER SPEC	6	L55 SERIES E26	NO	RIGHT	12"x54"x24"	TANK FS	4.0/4.0/4.0/4.0			YES	1181 LBS

HOOD OPTIONS

HOOD NO	TAG	OPTION
1		FIELD WRAPPER 18.00" HIGH FRONT, LEFT. BACKSLASH 80.00" HIGH X 312.00" LONG 430 SS VERTICAL. RISER SENSOR INSTALL 6IN PLEN.
2		FIELD WRAPPER 18.00" HIGH FRONT, RIGHT. RISER SENSOR INSTALL 6IN PLEN.

FIRE SYSTEM INFORMATION - JOB#5574303

FIRE SYSTEM NO	TAG	TYPE	SIZE	FLOW POINTS	INSTALLATION SYSTEM	LOCATION ON HOOD
1		TANK FS	4.0/4.0/4.0/4.0	74	FIRE CABINET RIGHT	RIGHT, HOOD 2

PERFORATED SUPPLY PLENUM(S)

HOOD NO	TAG	POS	LENGTH	WIDTH	HEIGHT	TYPE	RISER(S)		
							WIDTH	LENG	SP
1		F7491en916	156"	14"	6"	MUA	12"	24"	636 0.181"
							12"	24"	636 0.181"
							12"	24"	636 0.181"
							12"	28"	720 0.195"
2		F7491en916	156"	14"	6"	MUA	12"	28"	720 0.195"
							12"	28"	720 0.195"
							12"	28"	720 0.195"
							12"	28"	720 0.195"

CAPTIVE-AIRE HOODS ARE ETL LISTED AND LABELED IN COMPLIANCE WITH

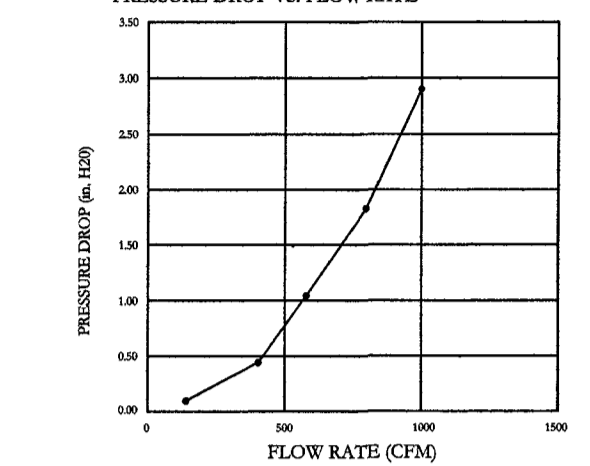
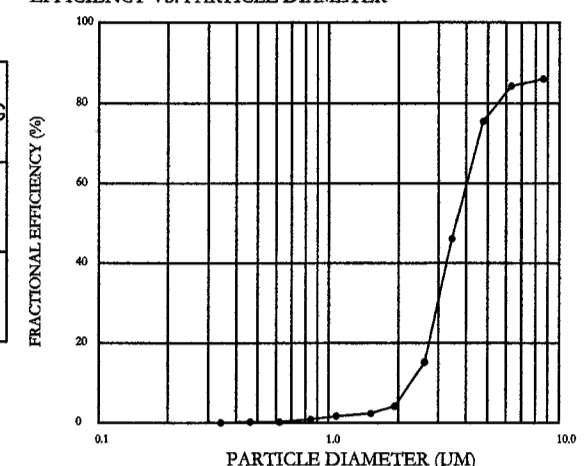


NFPA #96
 NSF
 UL 710 & ULC710 STANDARDS
 E.T.L. LISTED 3054804-001

SPECIFICATION: CAPTRATE GREASE-STOP SOLO FILTER

THE CAPTRATE GREASE-STOP SOLO FILTER IS A SINGLE-STAGE FILTER FEATURING A UNIQUE S-Baffle DESIGN IN CONJUNCTION WITH A SLOTTED REAR Baffle DESIGN, TO DELIVER EXCEPTIONAL FILTRATION EFFICIENCY.
 FILTER IS STAINLESS STEEL CONSTRUCTION, AND SIZED TO FIT INTO STANDARD 2-INCH DEEP HOOD CHANNEL(S).
 UNITS SHALL INCLUDE STAINLESS STEEL HANDLES AND A FASTENING DEVICE TO SECURE THE TWO COMPONENTS WHEN ASSEMBLED.

GREASE EXTRACTION EFFICIENCY PERFORMANCE SHALL REMOVE AT LEAST 75% OF GREASE PARTICLES FIVE MICRONS IN SIZE, AND 85% GREASE PARTICLES SEVEN MICRONS IN SIZE AND LARGER, WITH A CORRESPONDING PRESSURE DROP NOT TO EXCEED 1.0 INCHES OF WATER GAUGE. THE CAPTRATE GREASE-STOP SOLO WAS TESTED TO ASTM STANDARD ASTM F2519-05. MANUFACTURER APPROVED FOR USE IN SOLID FUEL APPLICATIONS AS A SPARK ARRESTER.



CAPTIVE FILTERS ARE BUILT IN COMPLIANCE WITH:
 NFPA #96.
 NSF STANDARD #2.
 UL STANDARD #1046.
 INT. MECH. CODE (M.C).
 ULC-5849.



REVISIONS

NO.	DESCRIPTION	DATE


CAPTIVE

CharlotterPiedmont
 www.captiveaire.com
 6303 Carmel Road, Suite 105, Charlotte, NC, 28226 PHONE: (704) 844-9088 FAX: (919) 227-5952 EMAIL: reg30@captiveaire.com

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 MONROE, NORTH CAROLINA
 28112, TEL: 704-283-2908
 FAX: 704-291-7909
cha.architects@frontier.com

CONSULTANTS


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12/20/22

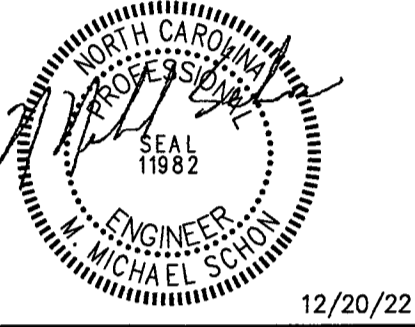**RESTAURANT
 AY CARAMBA I**

650 WEST ROOSEVELT BLVD.
 MONROE, NC 28110



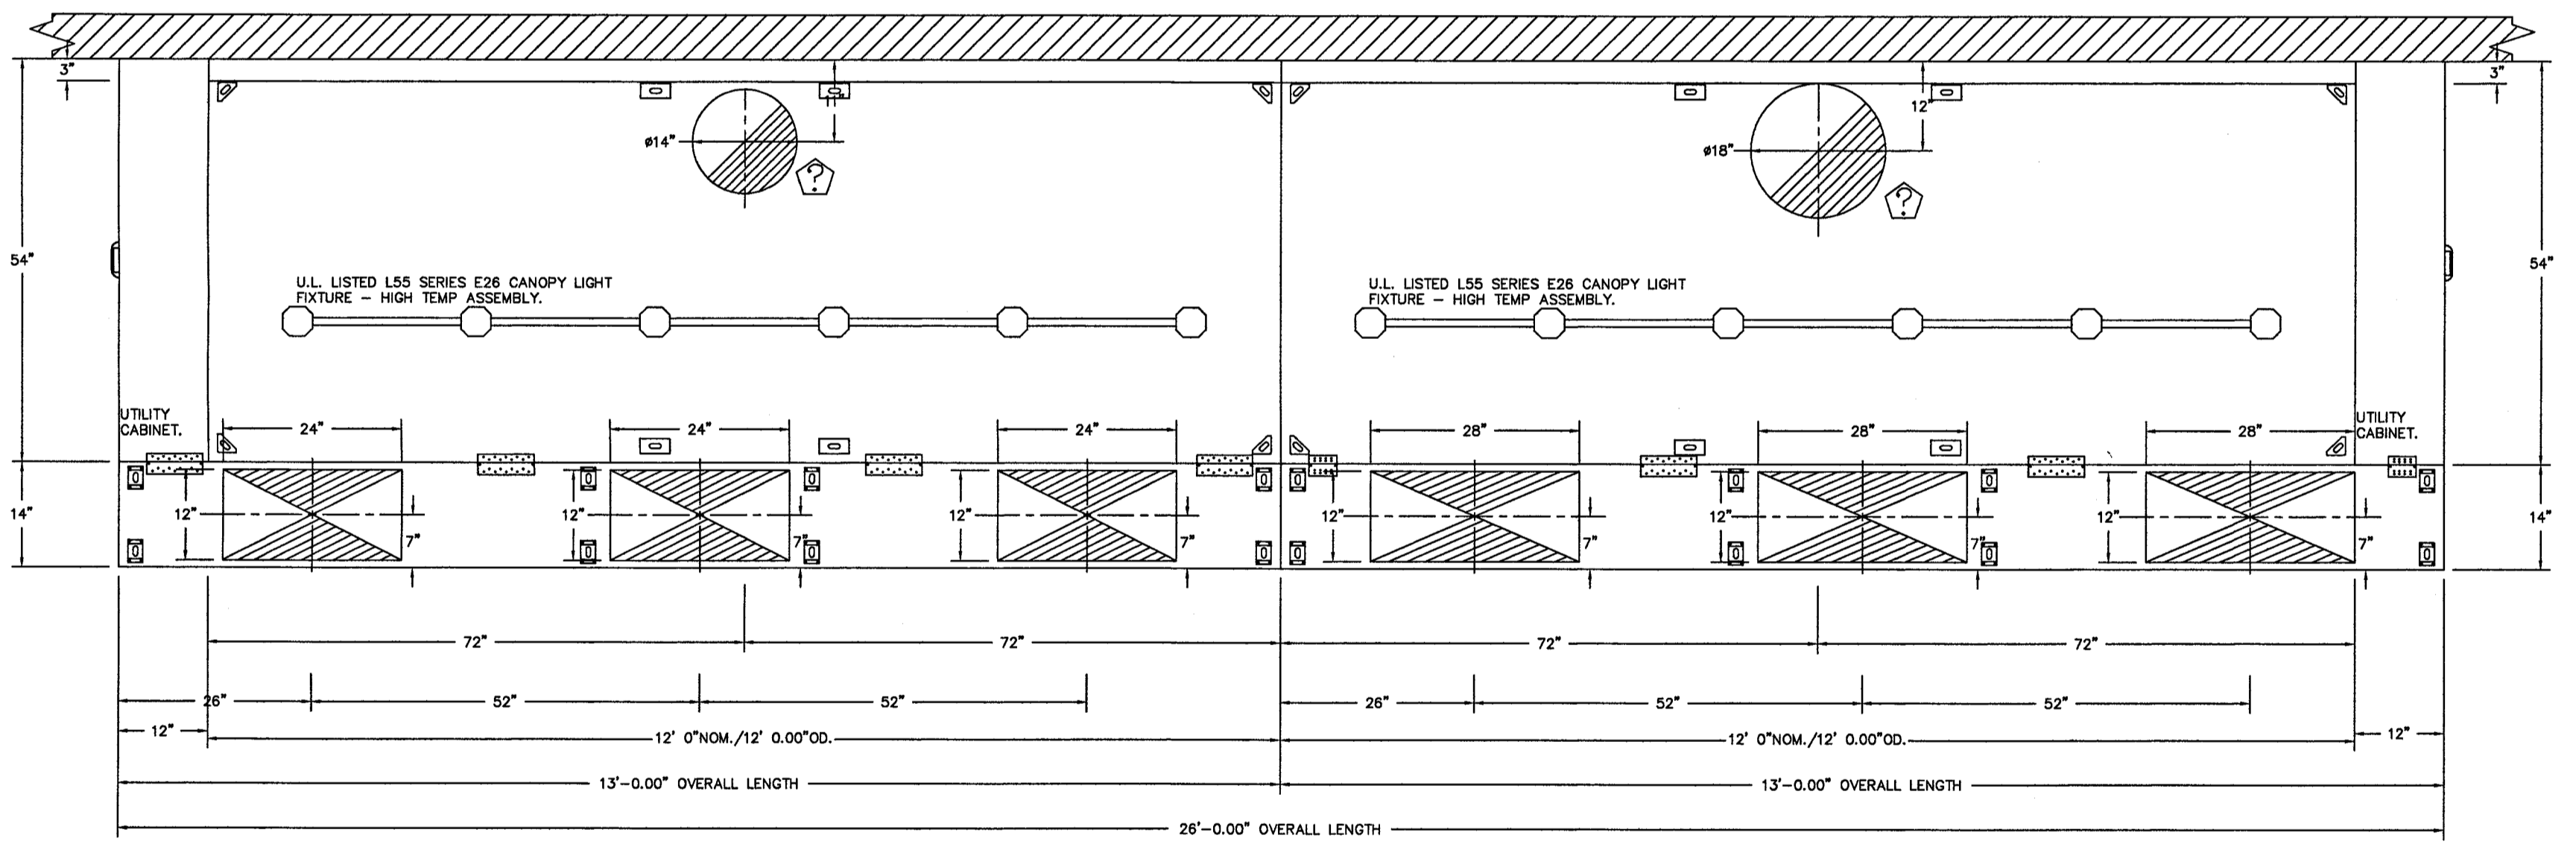PLAN VIEW - HOOD #1
 12' 0.00" LONG 5424ND-2-PSP-F
 NOTE: ADDITIONAL HANGING ANGLES PROVIDED FOR HOODS 12' AND LONGER.

PLAN VIEW - HOOD #2
 12' 0.00" LONG 5424ND-2-PSP-F
 NOTE: ADDITIONAL HANGING ANGLES PROVIDED FOR HOODS 12' AND LONGER.

AY CARAMBA - MONROE NC
 MONROE, NC, 28110

DATE: 7/27/2022
 DWG.#: 5574303
 DRAWN BY: reg30@captiveaire.com
 SCALE: 3/4" = 1'-0"
 MASTER DRAWING

SHEET NO. 1

MARK	DATE	DESCRIPTION

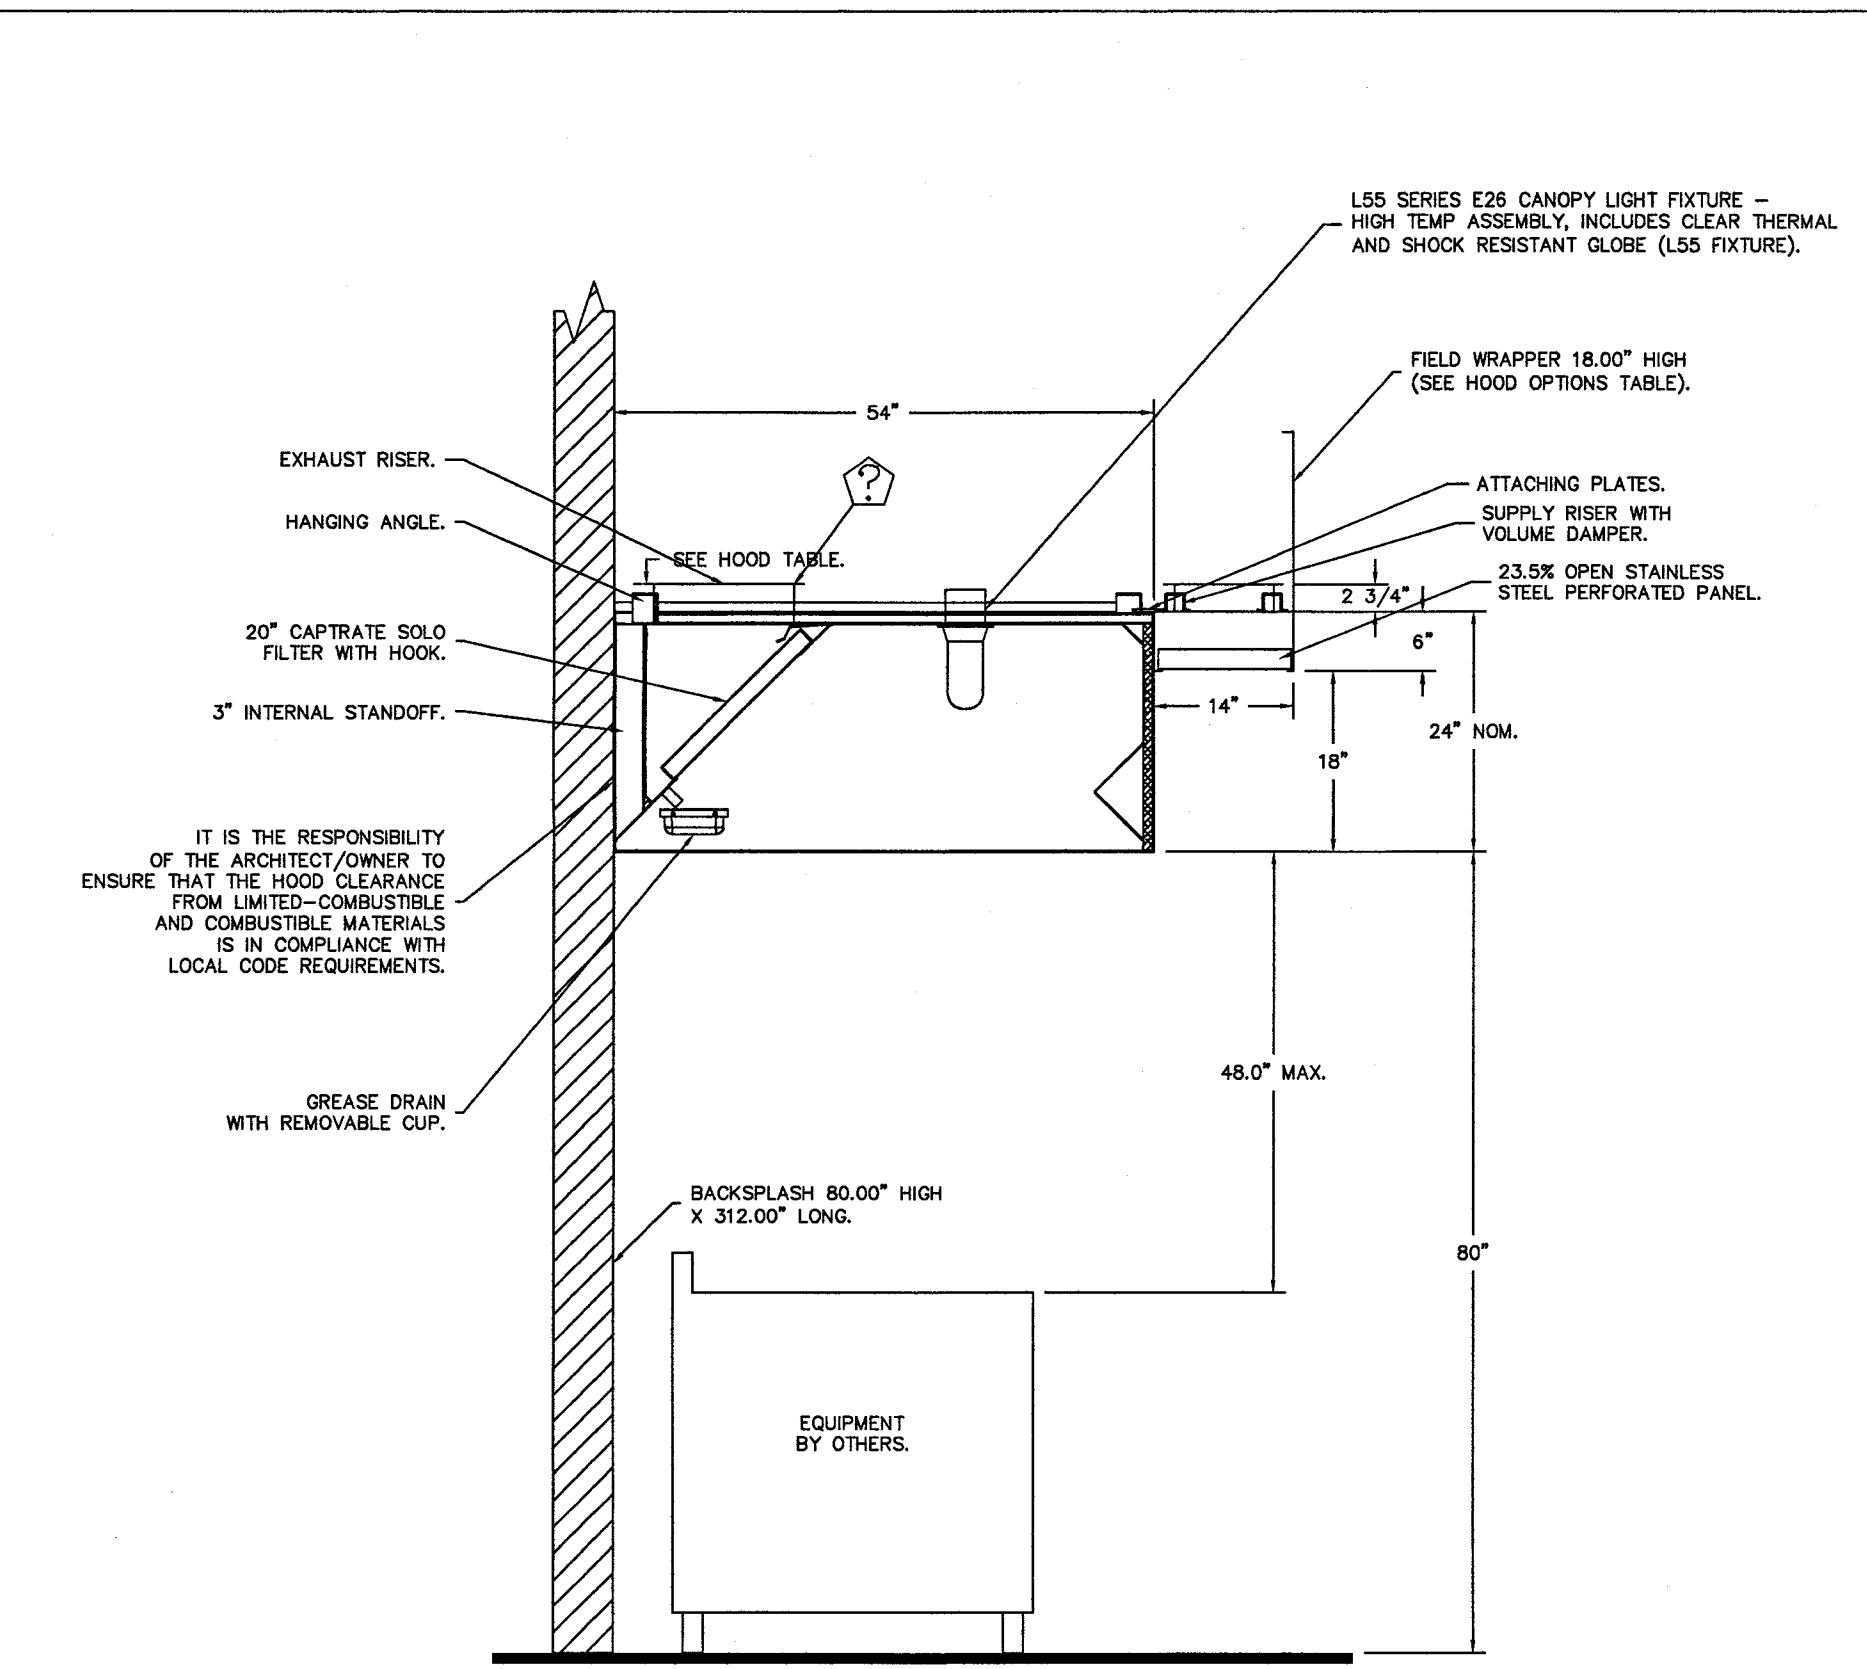
SHEET TITLE

KITCHEN HOOD INFORMATION


M3.1

Reviewed for Code Compliance
 City of Monroe Building Standards
 This project owner is responsible for compliance
 with all applicable Local, State and Federal laws.
 This professional does not provide a guarantee of any
 kind.
 Plans Exempt Date: 04/02/2022



1 2 3 4 5



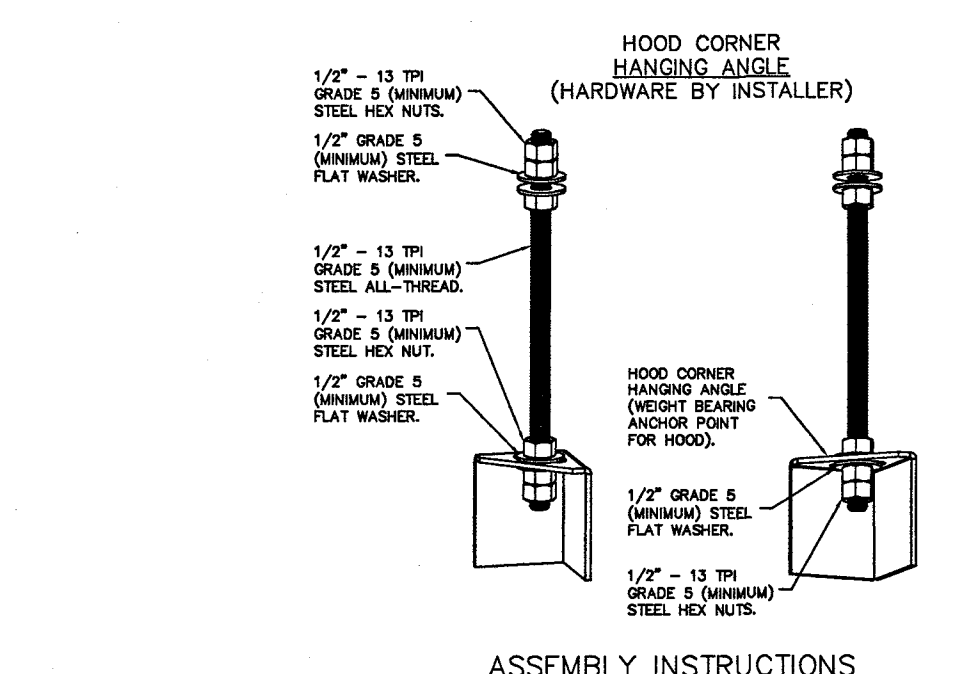SECTION VIEW - MODEL 5424ND-2-PSP-F
 HOOD - #1



ASSEMBLY INSTRUCTIONS
 HANGING ANGLE MUST BE SUPPORTED WITH 1/2" - 13 TPI GRADE 5 (MINIMUM) ALL-THREAD, SANDWICH HANGING ANGLES AND CEILING ANCHOR POINTS WITH 1/2" GRADE 5 (MINIMUM) STEEL FLAT WASHERS AND 1/2" - 13 TPI GRADE 5 (MINIMUM) STEEL HEX NUTS AS SHOWN. MUST USE DOUBLED HEX NUT CONFIGURATION BENEATH HOOD HANGING ANGLES AND ABOVE CEILING ANCHORS. MAINTAIN 1/4" OF EXPOSED THREADS BENEATH BOTTOM HEX NUT. TORQUE ALL HEX NUTS TO 57 FT-LBS.

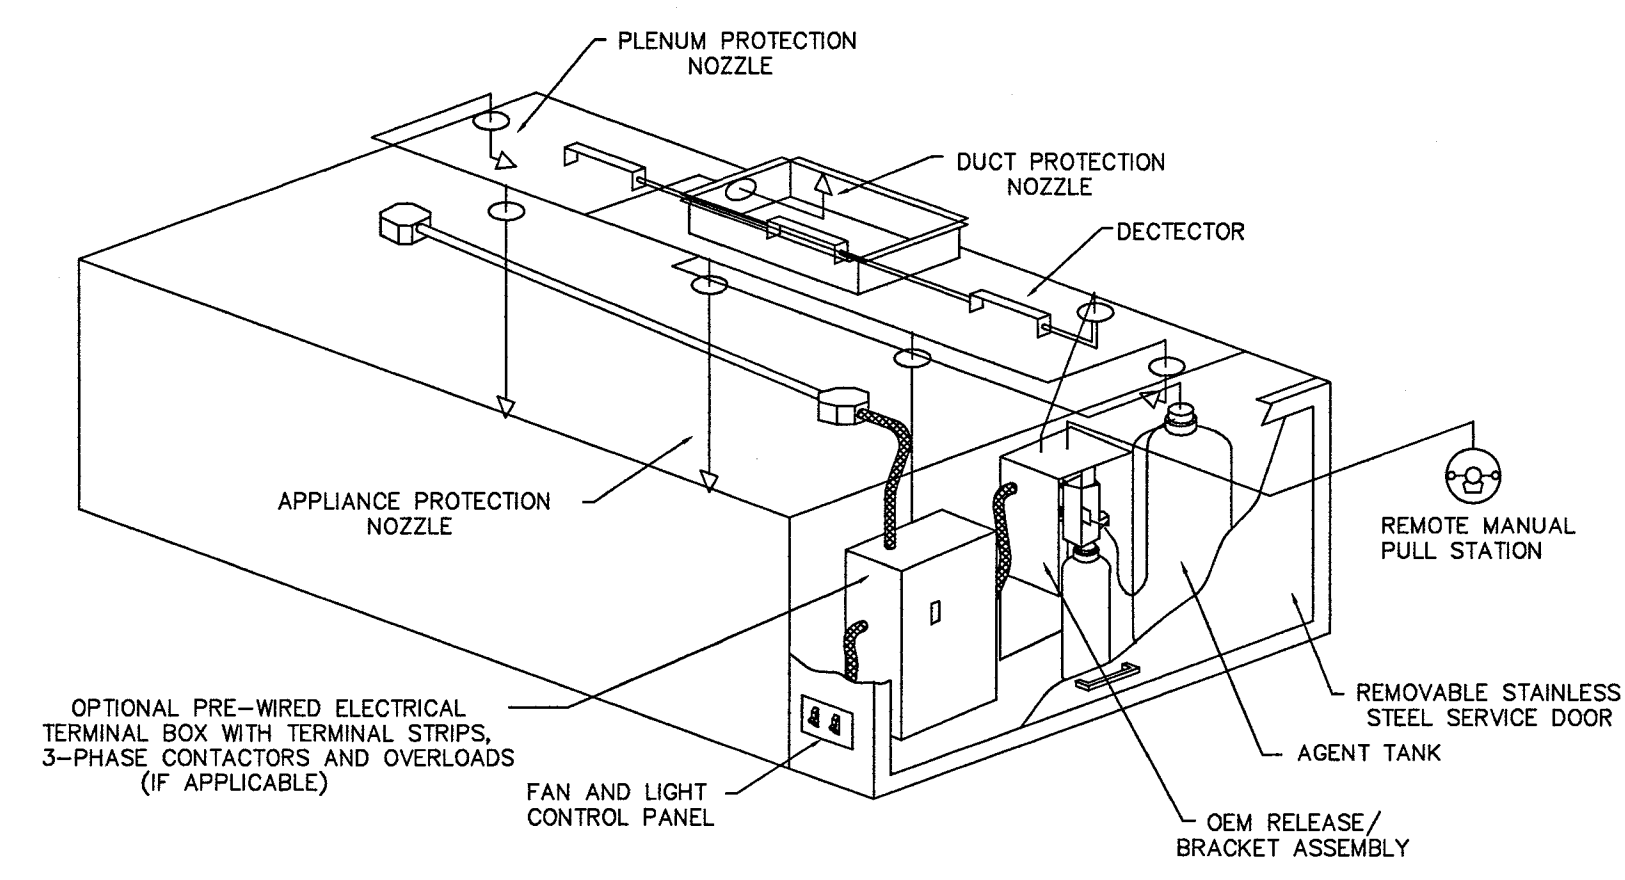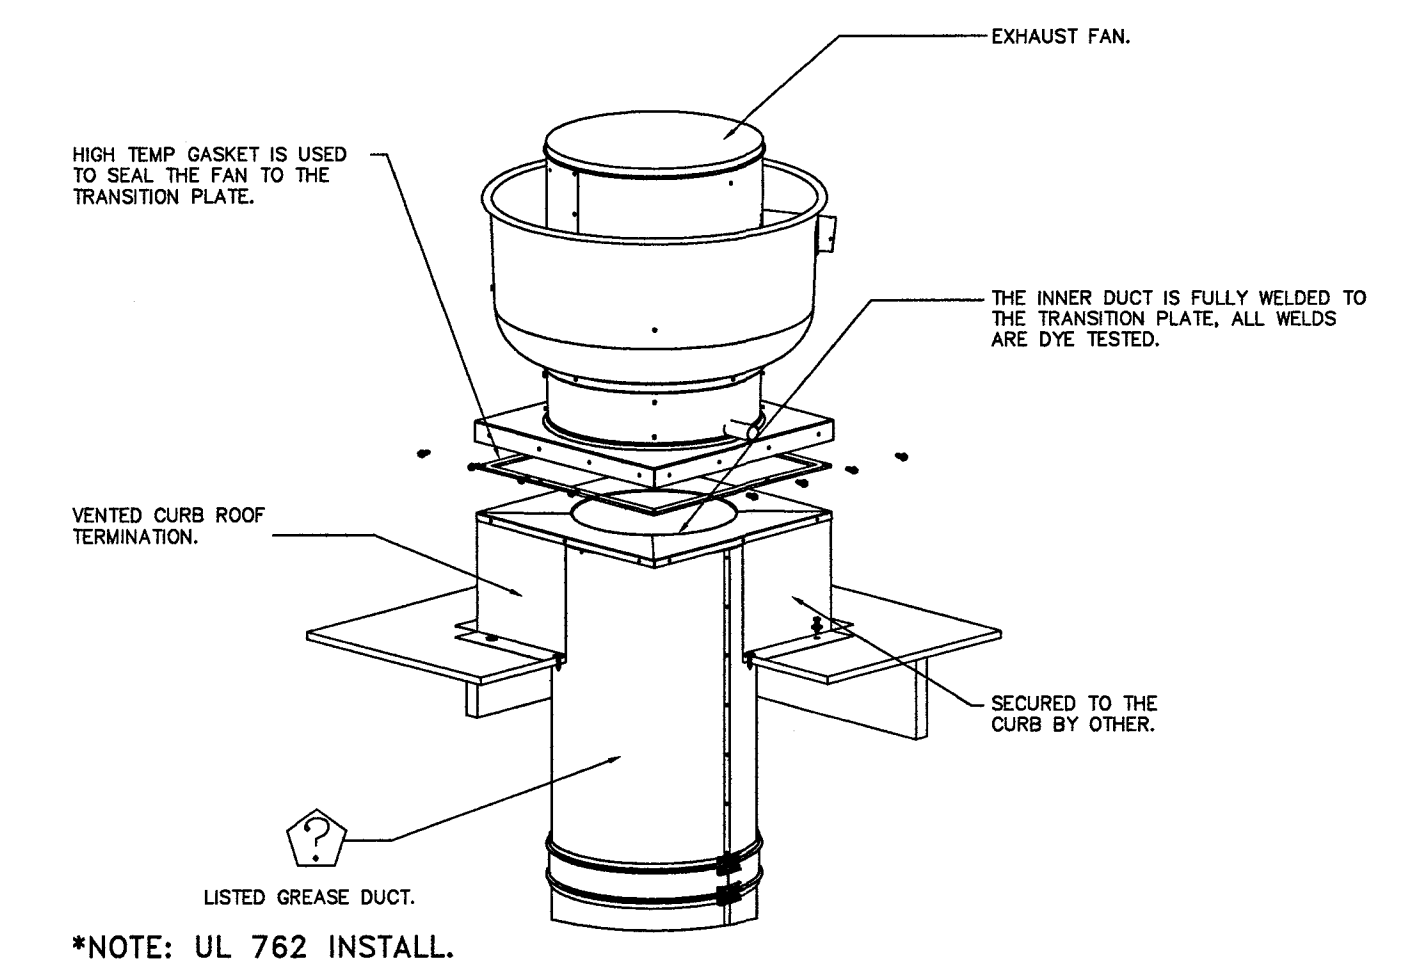

TYPICAL UL300 LIQUID FIRE SYSTEM LAYOUT

REVISIONS	
NO.	DESCRIPTION

CAPTIVE
 Charlotte/Piedmont
 6303 Carmel Road, Suite 105, Charlotte, NC 28226 PHONE: (704) 944-9088 FAX: (919) 227-5952 EMAIL: mg3@captiveware.com
 www.captiveware.com

AY CARAMBA - MONROE NC
 MONROE, NC, 28110

DATE: 7/27/2022
 DWG.#: 5574303
 DRAWN BY: 1/16/19/16/14/11/10/09/08/07/06/05/04/03/02/01
 SCALE: 3/4" = 1'-0"
 MASTER DRAWING

SHEET NO.
 2

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**RESTAURANT
 AY CARAMBA I**

650 WEST ROOSEVELT BLVD.
 MONROE, NC 28110

MARK	DATE	DESCRIPTION

SHEET TITLE

**KITCHEN HOOD
 INFORMATION**

M3.2

1 2 3 4 5

EXHAUST FAN INFORMATION – JOB#5574303

FAN UNIT NO	TAG	QTY	FAN UNIT MODEL #	MANUFACTURER	CFM	ESP	RPM	MOTOR ENCL	HP	BHP	PHASE	VOLT	FLA	DISCHARGE VELOCITY	WEIGHT (LBS)	SONES
1		1	DUI180HFA	CAPTIVEAIRE	2220	1.250	1120	ODP,PREMIUM	2.000	0.9590	3	208	6.1	513 FPM	158	13.6
2		1	DUI180HFA	CAPTIVEAIRE	2880	1.200	1209	ODP,PREMIUM	2.000	1.2440	3	208	8.3	665 FPM	182	17.4

CONDENSER DETAILS

FAN UNIT NO	TAG	FAN UNIT MODEL #	CONDENSER NO	TONNAGE	VOLTAGE	PHASE	FREQUENCY	MCA	RLA	MAX FUSE SIZE	MIN WIRE SIZE	SEER
3		A2-D.250-20D-MPU	1	5	208-230	3 PHASE	60 HZ	21.4 AMPS	17.4 AMPS	30 AMPS	10 AWG	14
			2	5	208-230	3 PHASE	60 HZ	21.4 AMPS	17.4 AMPS	30 AMPS	10 AWG	14

MUA FAN INFORMATION – JOB#5574303

FAN UNIT NO	TAG	QTY	FAN UNIT MODEL #	BLOWER	HOUSING	MIN CFM	DESIGN CFM	ESP	RPM	MOTOR ENCL	HP	BHP	PHASE	VOLT	FLA	MCA	MCCP	WEIGHT (LBS)	SONES
3		1	A2-D.250-20D-MPU	20MF-2-MOD	A2-D.250	3600	4069	0.500	1679	ODP,PREMIUM	3.000	2.6540	3	208	9.5	11.9A	20A	1813	17.6

COILS – JOB#5574303

FAN UNIT NO	TAG	COIL TYPE	DESIGN CFM	COOLING										HEATING										
				ENTERING DB TEMP	ENTERING WB TEMP	LEAVING DB TEMP	LEAVING WB TEMP	ENTERING FLUID TEMP	LEAVING FLUID TEMP	FLUID FLOW RATE	PERCENT GLYCOL	TOTAL CAPACITY	SENSIBLE CAPACITY	LATENT CAPACITY	ENTERING DB TEMP	LEAVING DB TEMP	ENTERING FLUID TEMP	LEAVING FLUID TEMP	FLUID FLOW RATE	PERCENT GLYCOL	STEAM PRESSURE	TOTAL CAPACITY	SENSIBLE CAPACITY	
3		DX	4069	92.0°F	74.0°F	75.2°F	67.1°F	---	---	---	---	100.5 MBH	70.7 MBH	29.8 MBH	---	---	---	---	---	---	---	---	---	---

GAS FIRED MAKE-UP AIR UNIT(S)

FAN UNIT NO	TAG	INPUT BTU/H	OUTPUT BTU/H	TEMP RISE	REQUIRED INPUT GAS PRESSURE	GAS TYPE	BURNER EFFICIENCY(%)
3		231412	212899	50°F	7 IN. W.C. – 14 IN. W.C.	NATURAL	92

FAN OPTIONS

FAN UNIT NO	TAG	QTY	DESCRIPTION
1		1	GREASE BOX
		1	2 YEAR PARTS WARRANTY
2		1	GREASE BOX
		1	2 YEAR PARTS WARRANTY
3		1	INLET PRESSURE GAUGE, 0-35"
		1	MANIFOLD PRESSURE GAUGE, -5 TO 15" WC
		1	LOW FIRE START
		1	SHIP LOOSE GAS STRAINER 1"
		1	AC INTERLOCK RELAY – 24VAC COIL
		1	MOTORIZED BACKDRAFT DAMPER FOR A2-D HOUSING – MEETS AMCA CLASS 1A RATING
		1	10 TON 2 CIRCUIT (5/5) MODULAR PACKAGED COOLING OPTION FOR SIZE 2 DF/EH MUA (3,600 TO 5,000 CFM), 208V/230V, 3 PHASE. COOLING THERMOSTAT OR PROGRAMMABLE STAT REQUIRED FOR PROPER OPERATION
		1	DOWNTURN PLENUM FOR SIZE 2 DX COIL MODULE
		1	SEPARATE 120V WIRING PACKAGE (REQUIRED AND USED ONLY FOR DCV OR PREWIRE WITH VFD) – THREE PHASE ONLY
		1	COOLING THERMOSTAT AND RELAY (NOT REQUIRED FOR EVAP)
		1	2 YEAR PARTS WARRANTY



FAN ACCESSORIES

FAN UNIT NO	TAG	EXHAUST			SUPPLY			
		GREASE CUP	GRAVITY DAMPER	WALL MOUNT	SIDE DISCHARGE	GRAVITY DAMPER	MOTORIZED DAMPER	WALL MOUNT
1		YES						
2		YES						
3						YES		

CURB ASSEMBLIES

NO	ON FAN	WEIGHT	ITEM	SIZE
1	# 1	34 LBS	CURB	26.500"W X 26.500"L X 26.000"H ALONG LENGTH, RIGHT VENTED HINGED.
2	# 2	30 LBS	CURB	26.500"W X 26.500"L X 26.000"H ALONG LENGTH, RIGHT VENTED.
3	# 3	96 LBS	RAIL	6.000"W X 31.000"L X 15.000"H RIGHT.
3	# 3	96 LBS	CURB	31.000"W X 79.000"L X 15.000"H ALONG WIDTH, RIGHT INSULATED.

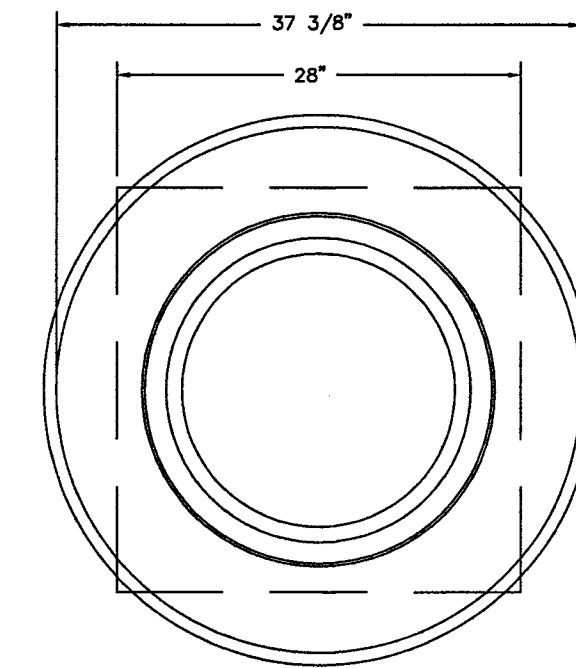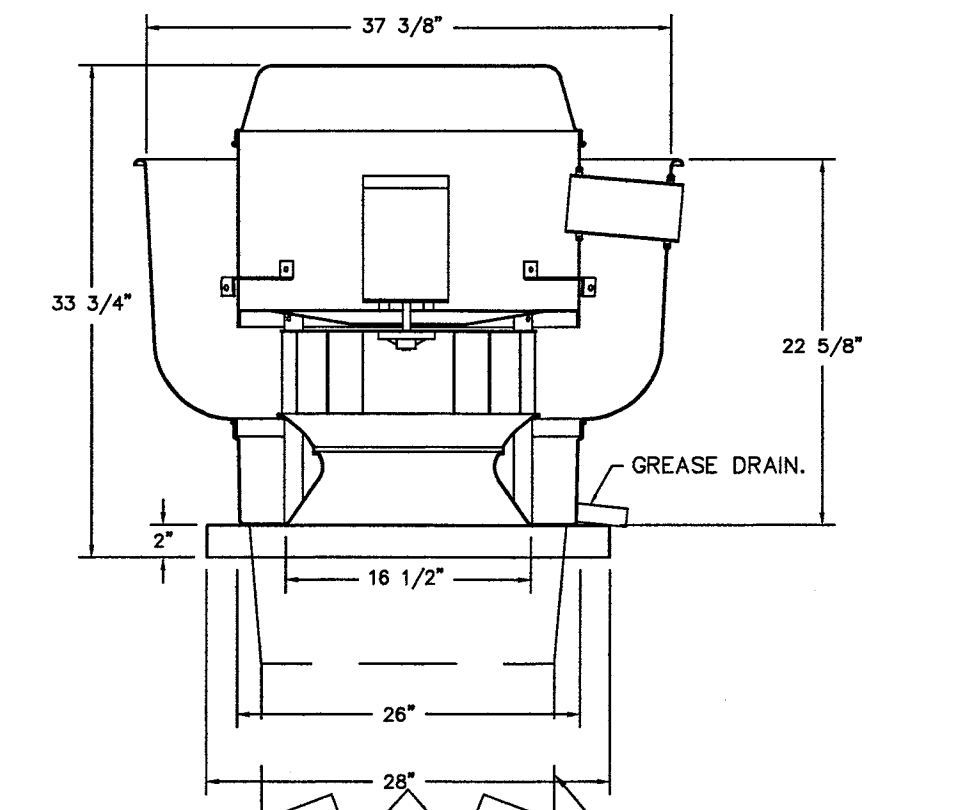FAN #1 DUI180HFA – EXHAUST FAN



TOP VIEW

FEATURES:

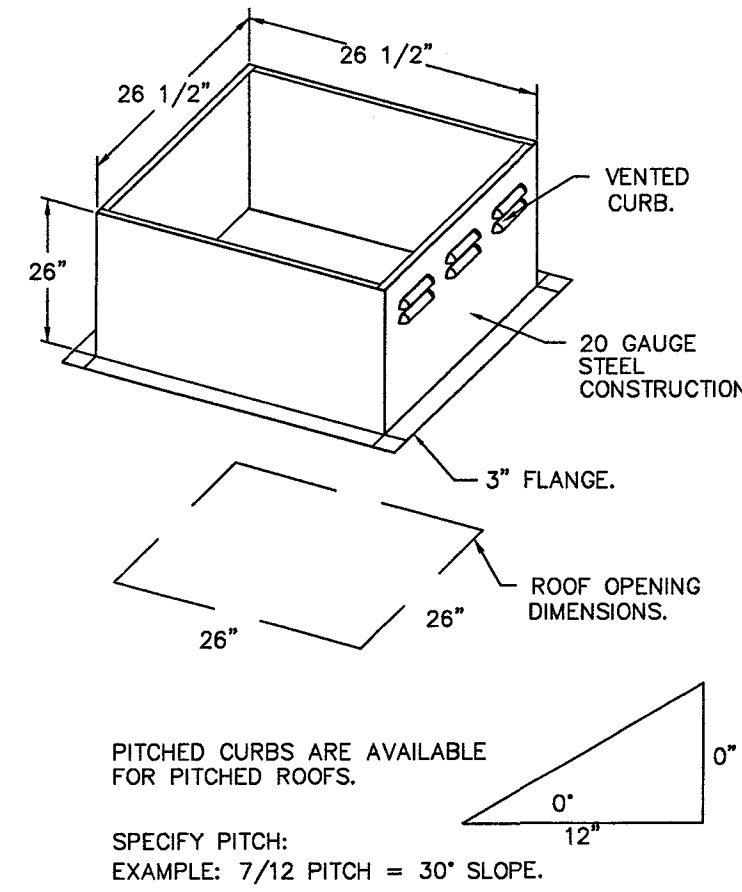
- DIRECT DRIVE CONSTRUCTION (NO BELTS/PULLEYS).
- ROOF MOUNTED FANS.
- RESTAURANT MODEL.
- UL705 AND UL782 AND UL6-S845
- VARIABLE SPEED CONTROL.
- INTERNAL WIRING.
- THERMAL OVERLOAD PROTECTION (SINGLE PHASE).
- HIGH HEAT OPERATION 300°F (149°C).
- GREASE CLASSIFICATION TESTING.
- NEMA 3R SAFETY DISCONNECT SWITCH.

NORMAL TEMPERATURE TEST
 EXHAUST FAN MUST OPERATE CONTINUOUSLY WHILE EXHAUSTING AIR AT 300°F (149°C) UNTIL ALL FAN PARTS HAVE REACHED THERMAL EQUILIBRIUM, AND WITHOUT ANY DETRIMENTARY EFFECTS TO THE FAN WHICH WOULD CAUSE UNSAFE OPERATION.

ABNORMAL FLARE-UP TEST
 EXHAUST FAN MUST OPERATE CONTINUOUSLY WHILE EXHAUSTING BURNING GREASE VAPORS AT 600°F (316°C) FOR A PERIOD OF 15 MINUTES WITHOUT THE FAN BECOMING DAMAGED TO ANY EXTENT THAT COULD CAUSE AN UNSAFE CONDITION.

OPTIONS

- GREASE BOX.
- 2 YEAR PARTS WARRANTY.



PITCHED CURBS ARE AVAILABLE FOR PITCHED ROOFS.

SPECIFY PITCH:
 EXAMPLE: 7/12 PITCH = 30° SLOPE.

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12/20/22

**RESTAURANT
 AY CARAMBA I**

650 WEST ROOSEVELT BLVD.
 MONROE, NC 28110

MARK	DATE	DESCRIPTION

ISSUE: 08/29/2022

PROJECT NO: 22159

CAD DWG FILE: SEE DRAWINGS


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KITCHEN HOOD INFORMATION

M3.3



FAN #2 DUISBCHA - EXHAUST FAN

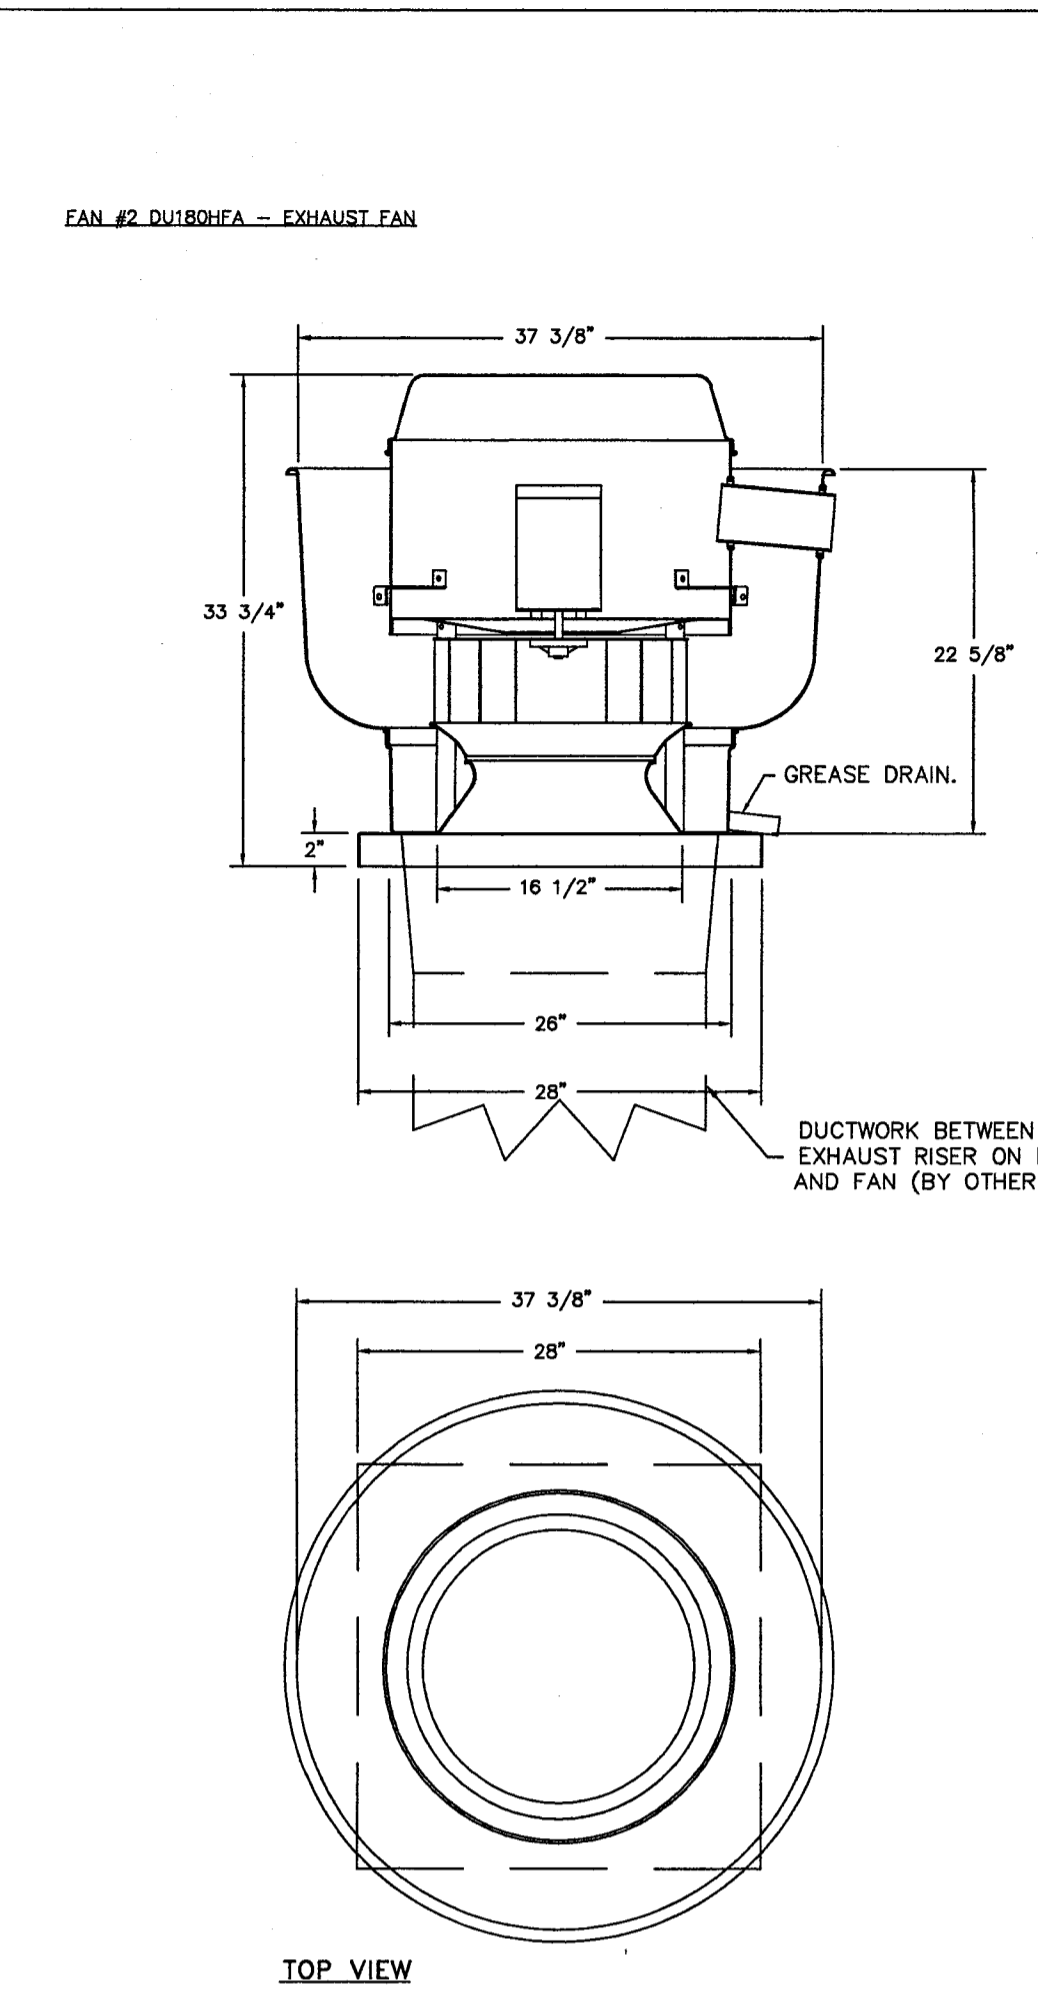FEATURES:


- DIRECT DRIVE CONSTRUCTION (NO BELTS/PULLEYS).
- ROOF MOUNTED FANS.
- RESTAURANT MODEL.
- UL705 AND UL762 AND ULC-S645
- VARIABLE SPEED CONTROL.
- INTERNAL WIRING.
- THERMAL OVERLOAD PROTECTION (SINGLE PHASE).
- HIGH HEAT OPERATION 300°F (149°C).
- GREASE CLASSIFICATION TESTING.
- NEMA 3R SAFETY DISCONNECT SWITCH.

NORMAL TEMPERATURE TEST
 EXHAUST FAN MUST OPERATE CONTINUOUSLY WHILE EXHAUSTING AIR AT 300°F (149°C) UNTIL ALL FAN PARTS HAVE REACHED THERMAL EQUILIBRIUM, AND WITHOUT ANY DETERIORATING EFFECTS TO THE FAN WHICH WOULD CAUSE UNSAFE OPERATION.

ABNORMAL FLARE-UP TEST
 EXHAUST FAN MUST OPERATE CONTINUOUSLY WHILE EXHAUSTING BURNING GREASE VAPORS AT 600°F (316°C) FOR A PERIOD OF 15 MINUTES WITHOUT THE FAN BECOMING DAMAGED TO ANY EXTENT THAT COULD CAUSE AN UNSAFE CONDITION.

OPTIONS
 GREASE BOX.
 2 YEAR PARTS WARRANTY.

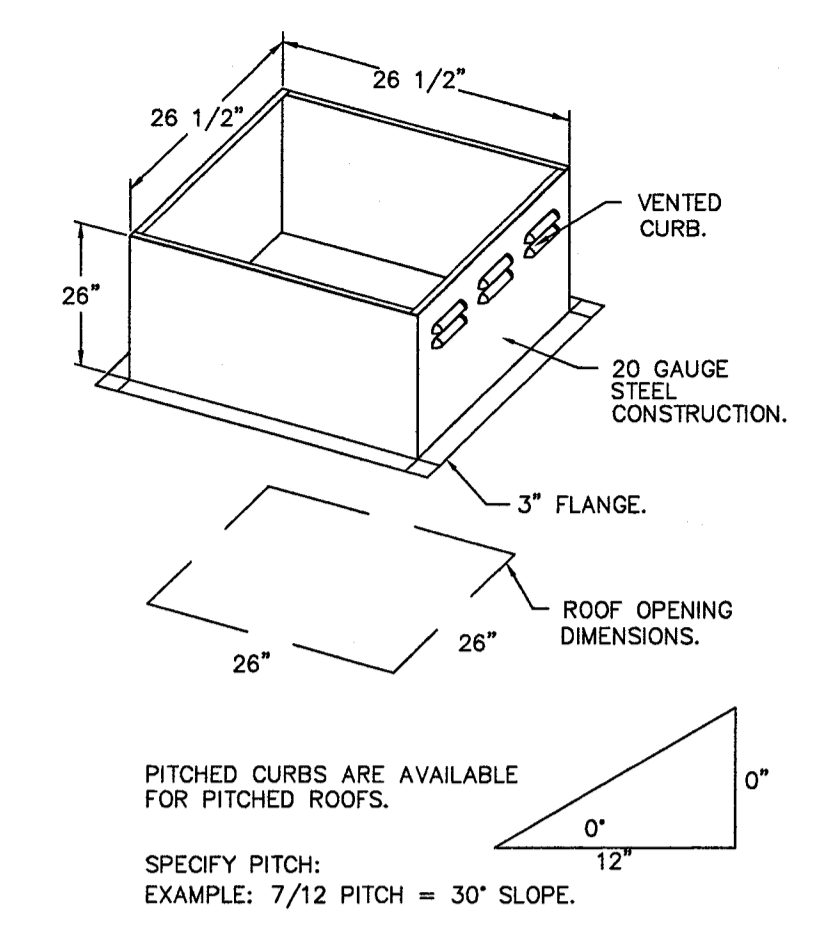DUCTWORK BETWEEN EXHAUST RISER ON HOOD AND FAN (BY OTHERS).



REVISIONS

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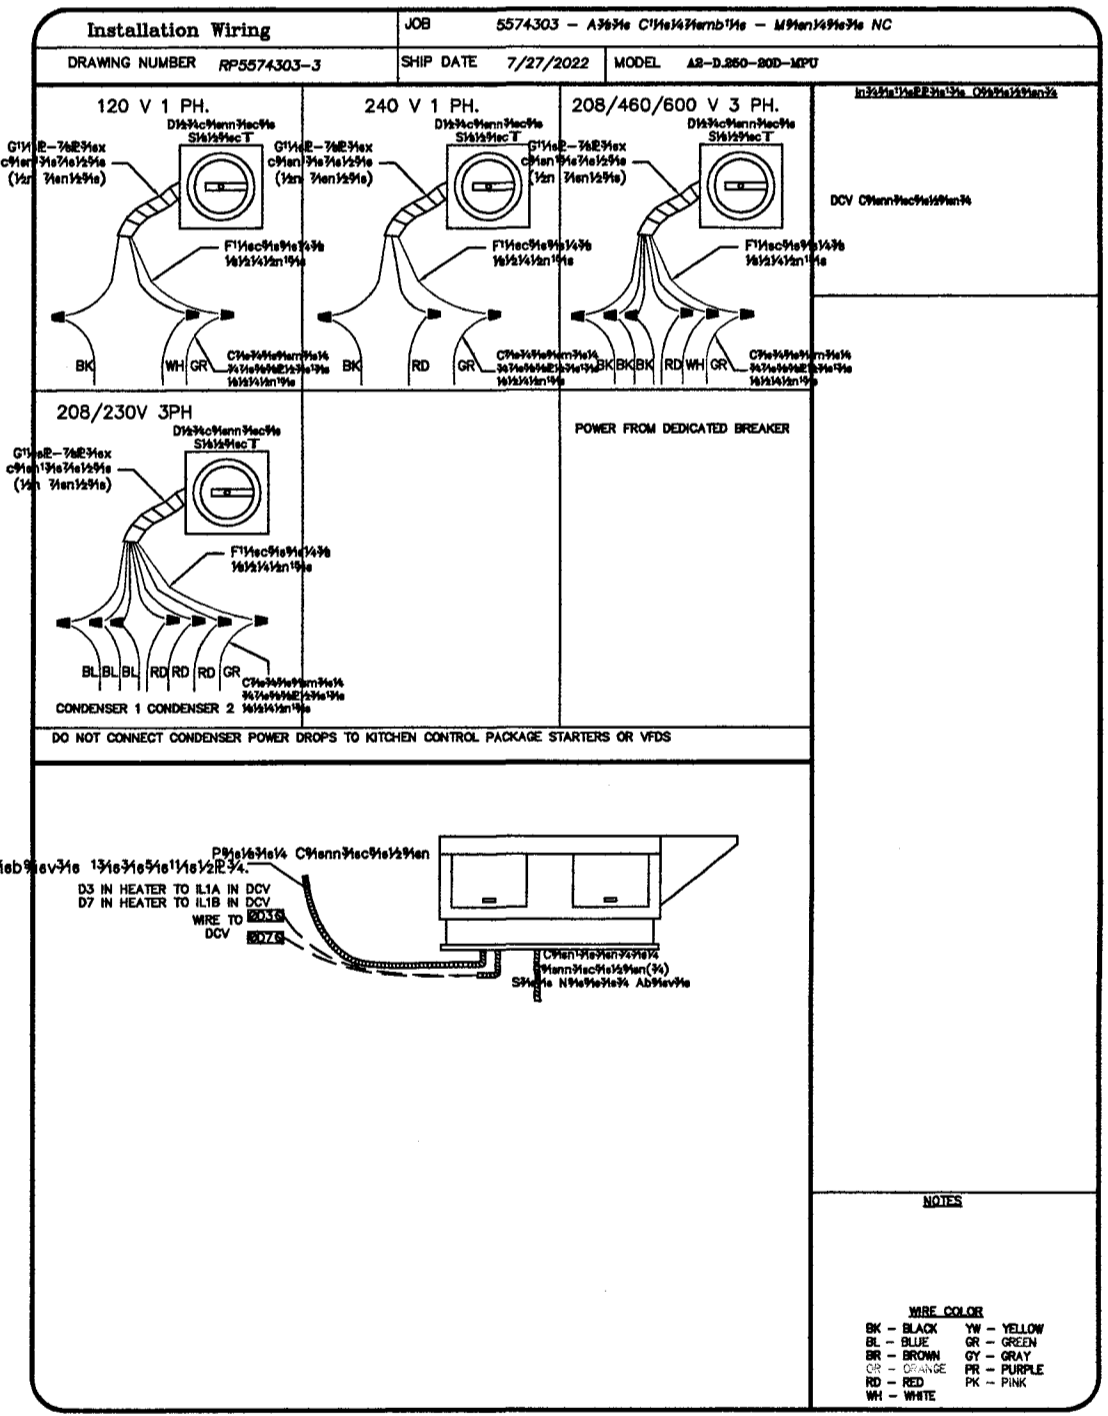
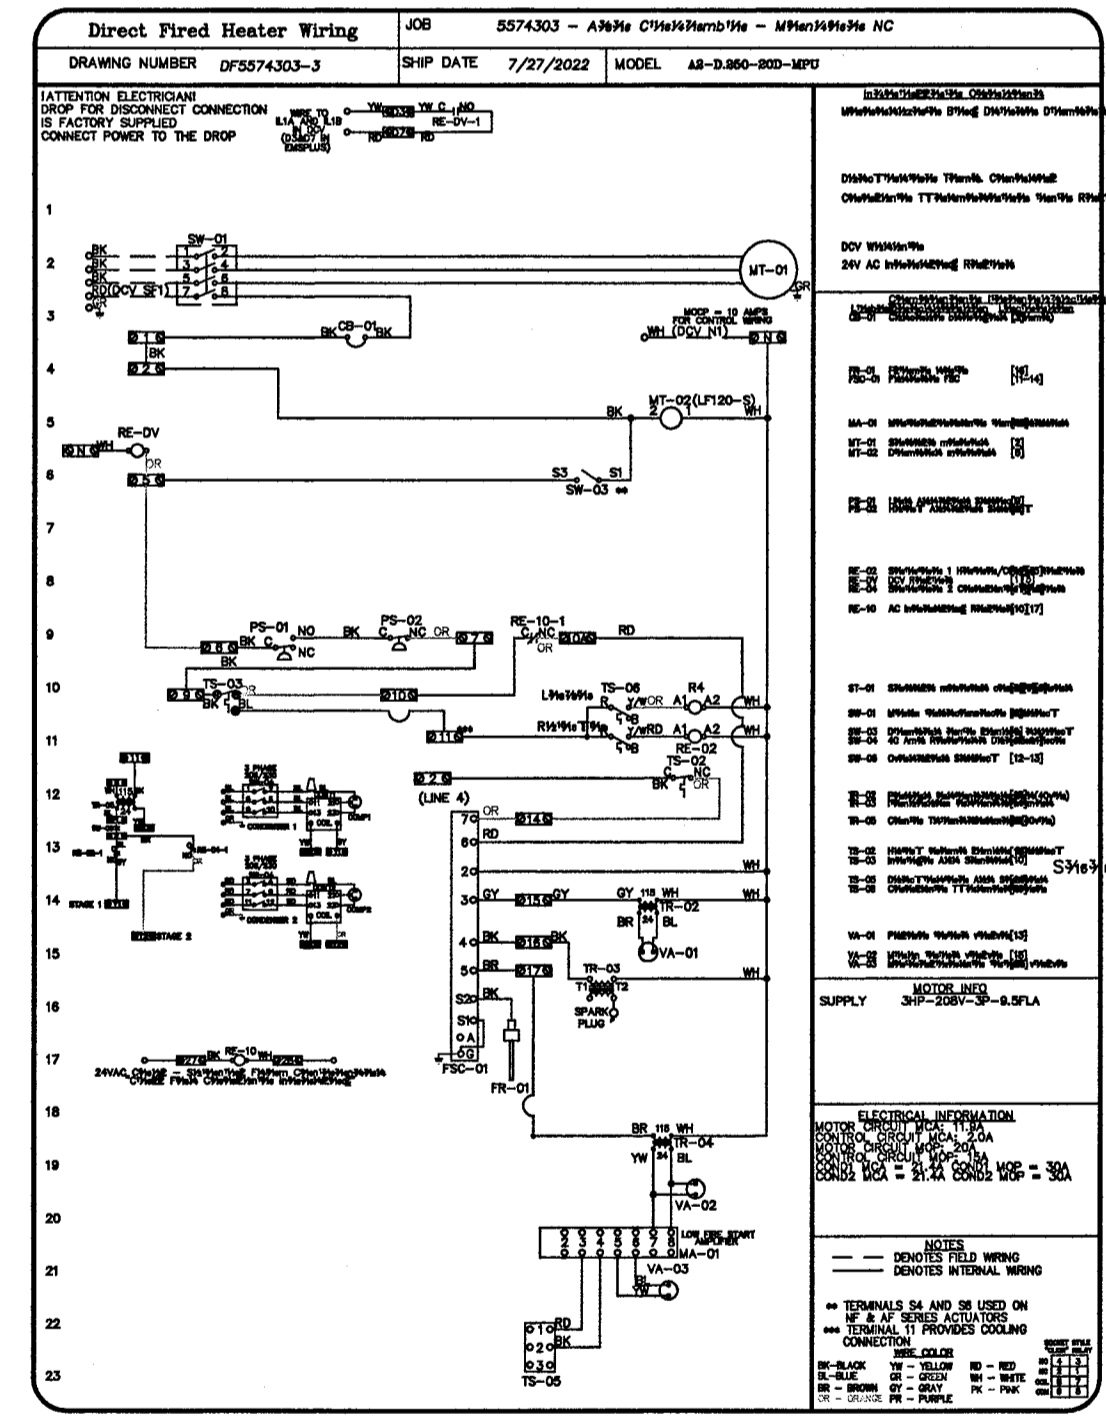
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 MONROE, NC, 28110

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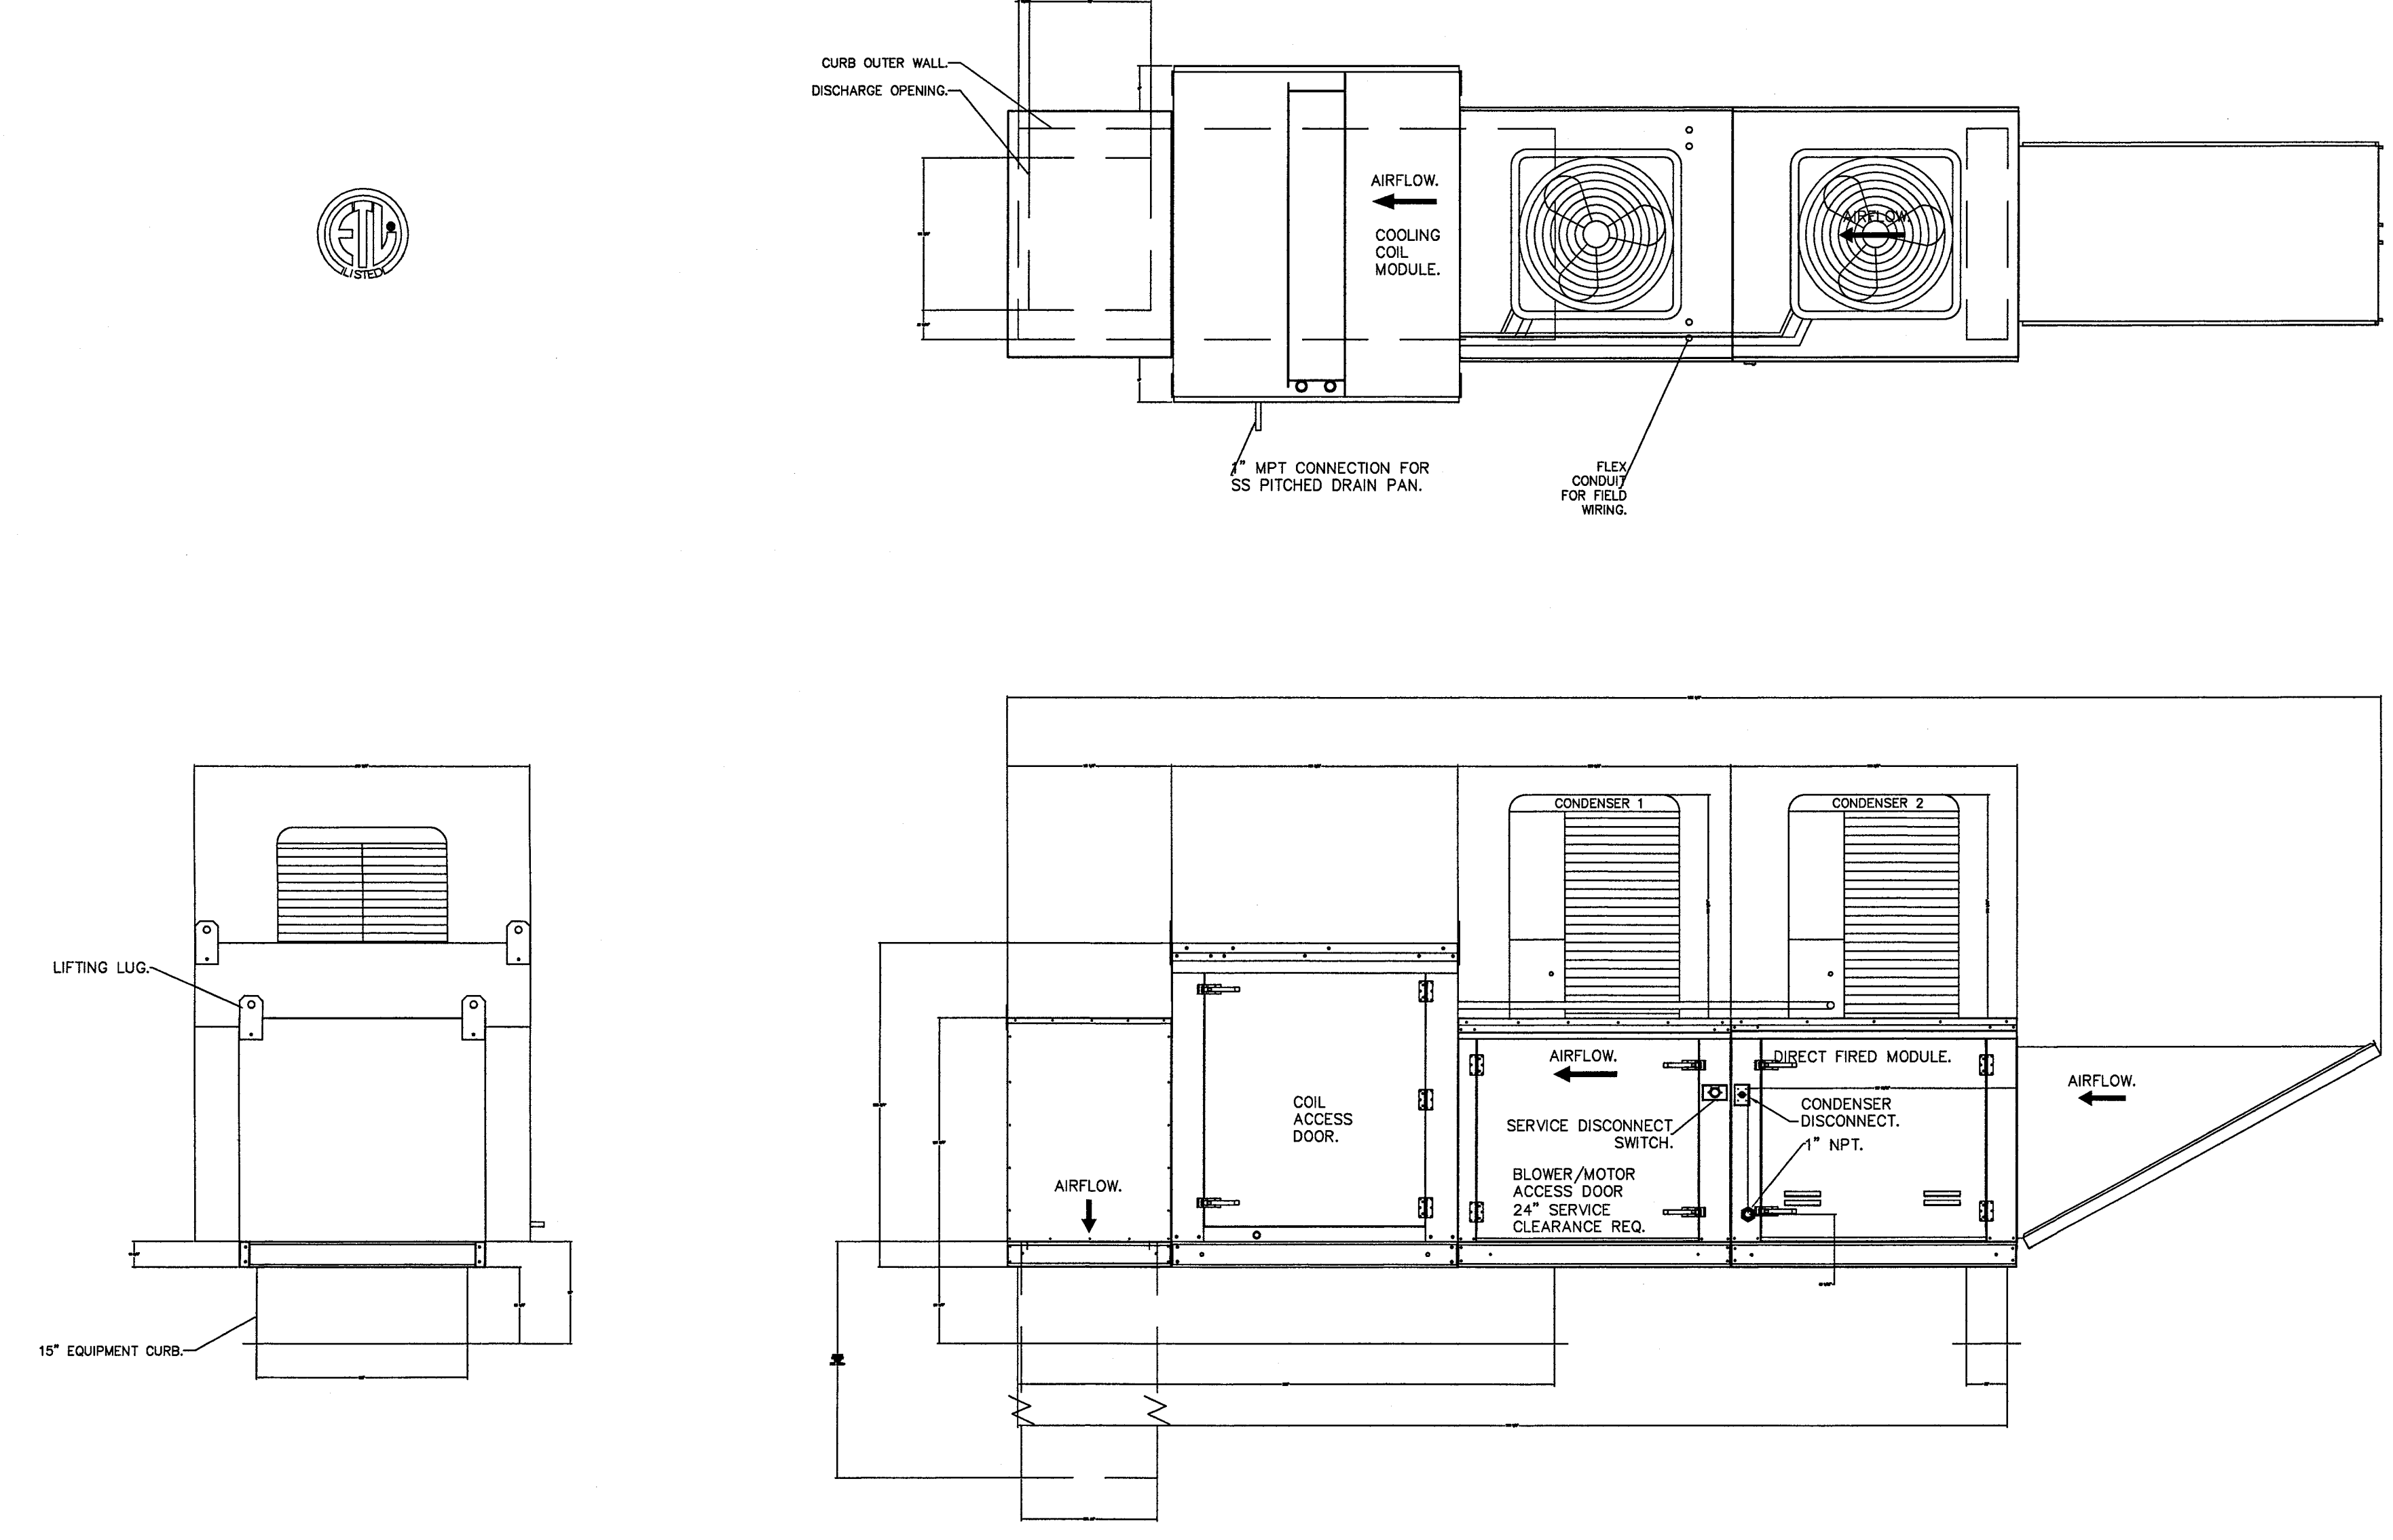
KITCHEN HOOD
INFORMATION

M3.4

- FAN #3 A2-D-250-20D-MPU - HEATER
1. DIRECT GAS FIRED HEATED MAKE UP AIR UNIT WITH 20" MIXED FLOW DIRECT DRIVE FAN.
 2. INTAKE HOOD WITH EZ FILTERS.
 3. DOWN DISCHARGE - AIR FLOW RIGHT -> LEFT.
 4. GAS PRESSURE GAUGE, 0-30", 2.5" DIAMETER, 1/4" THREAD SIZE.
 5. GAS PRESSURE GAUGE, -5 TO +15 INCHES WC, 2.5" DIAMETER, 1/4" THREAD SIZE.
 6. LOW FIRE START, ALLOWS THE BURNER CIRCUIT TO ENERGIZE WHEN THE MODULATION CONTROL IS IN A LOW FIRE POSITION.
 7. SHIP LOOSE GAS STRAINER, TO BE INSTALLED UPSTREAM OF UNIT CONNECTION, 1" CONNECTION.
 8. COOLING INTERLOCK RELAY, 24VAC COIL, 120V CONTACTS. LOCKS OUT BURNER CIRCUIT WHEN AC IS ENERGIZED.
 9. MOTORIZED BACK DRAFT DAMPER 22.75" X 24" FOR SIZE 2 STANDARD IN MODULAR HEATER UNITS W/EXTENDED SHAFT, STANDARD GALVANIZED CONSTRUCTION, 3/4" REAR FLANGE, LOW LEAKAGE, LF120S ACTUATOR INCLUDED.
 10. 10 TON, DUAL CIRCUIT (S/S) MODULAR PACKAGED COOLING OPTION FOR SIZE 2 DF/EH MODULAR PACKAGED UNIT. INCLUDES CONDENSER, DX COIL, FILTER/DRYER KIT, THERMAL EXPANSION VALVE, R410A REFRIGERANT, AND REFRIGERANT PIPING. (3,600 TO 5,000 CFM) WHEN ORDERED WITH OPPOSITE AIRFLOW CONDENSERS ACCESS AND COIL PIPING WILL REMAIN IN STANDARD POSITION, DRAIN AND SLEDS WILL MOVE TO THE OPPOSITE SIDE. ANY OTHER CHANGE WILL REQUIRE CJI. CONDENSERS REQUIRE SEPARATE 208V, 3 PHASE POWER SUPPLY UNLESS ORDERED WITH SINGLE POINT CONNECTION. COIL # 3Z20802B.
 11. DOWNTURN PLENUM FOR SIZE 2 COOLING COIL MODULE - REQUIRED FOR DOWN DISCHARGE COOLING COIL APPLICATIONS.
 12. SEPARATE 120VAC WIRING PACKAGE FOR MAKE-UP AIR UNITS. OPTION MUST BE SELECTED WHEN MOUNTING YTD IN PREWIRE PANEL OR WITH DCV PACKAGE. PROVIDES SEPARATE 120VAC INPUT TO SUPPLY FAN. THIS 120V SIGNAL MUST BE RUN BY ELECTRICIAN FROM DCV TO MUA SWITCH.
 13. DX COOLING INTAKE AIR THERMOSTAT AND RELAYS MOUNTED IN UNIT - SET POINT FOR THERMOSTAT SHOULD BE 85F.
 14. HINGED DOUBLE WALL INSULATED DOOR ASSEMBLY (BURNER/BLOWER/MPU SECTION).
 15. 2 YEAR PARTS WARRANTY.

*NOTE: SUPPLY DUCT MUST BE INSTALLED TO MEET SMACNA STANDARDS. A MINIMUM STRAIGHT DUCT LENGTH MUST BE MAINTAINED DOWNSTREAM OF UNIT DISCHARGE AS OUTLINED IN AMCA PUBLICATION 201. WHEN USING RECTANGULAR DUCTWORK, ELBOWS MUST BE RADIUS THROAT, RADIUS BACK WITH TURNING VANES. FLEXIBLE DUCTWORK AND SQUARE THROAT/SQUARE BACK ELBOWS SHOULD NOT BE USED. ANY TRANSITION AND/OR TURNS IN THE DUCTWORK WILL CAUSE SYSTEM EFFECT. SYSTEM EFFECT WILL DRASTICALLY INCREASE STATIC PRESSURE AND REDUCE AIRFLOW. DO NOT RELY ON UNIT TO SUPPORT DUCT IN ANY WAY. FAILURE TO PROPERLY SIZE DUCTWORK MAY CAUSE SYSTEM EFFECTS AND REDUCE PERFORMANCE OF THE EQUIPMENT. SUGGESTED STRAIGHT DUCT SIZE IS 20" x 20".

SUPPLY SIDE HEATER INFORMATION:
 WINTER TEMPERATURE = 25F, TEMP. RISE = 50F,
 BTUH₁ CALCULATED OFF ACTUAL AIR DENSITY,
 OUTPUT BTUH₁ AT ALTITUDE OF 0.0 FT. = 217354,
 INPUT BTUH₁ AT ALTITUDE OF 0.0 FT. = 236254,
 OUTPUT BTUH₂ AT ALTITUDE OF 572 FT. = 212899,
 INPUT BTUH₂ AT ALTITUDE OF 572 FT. = 231411.



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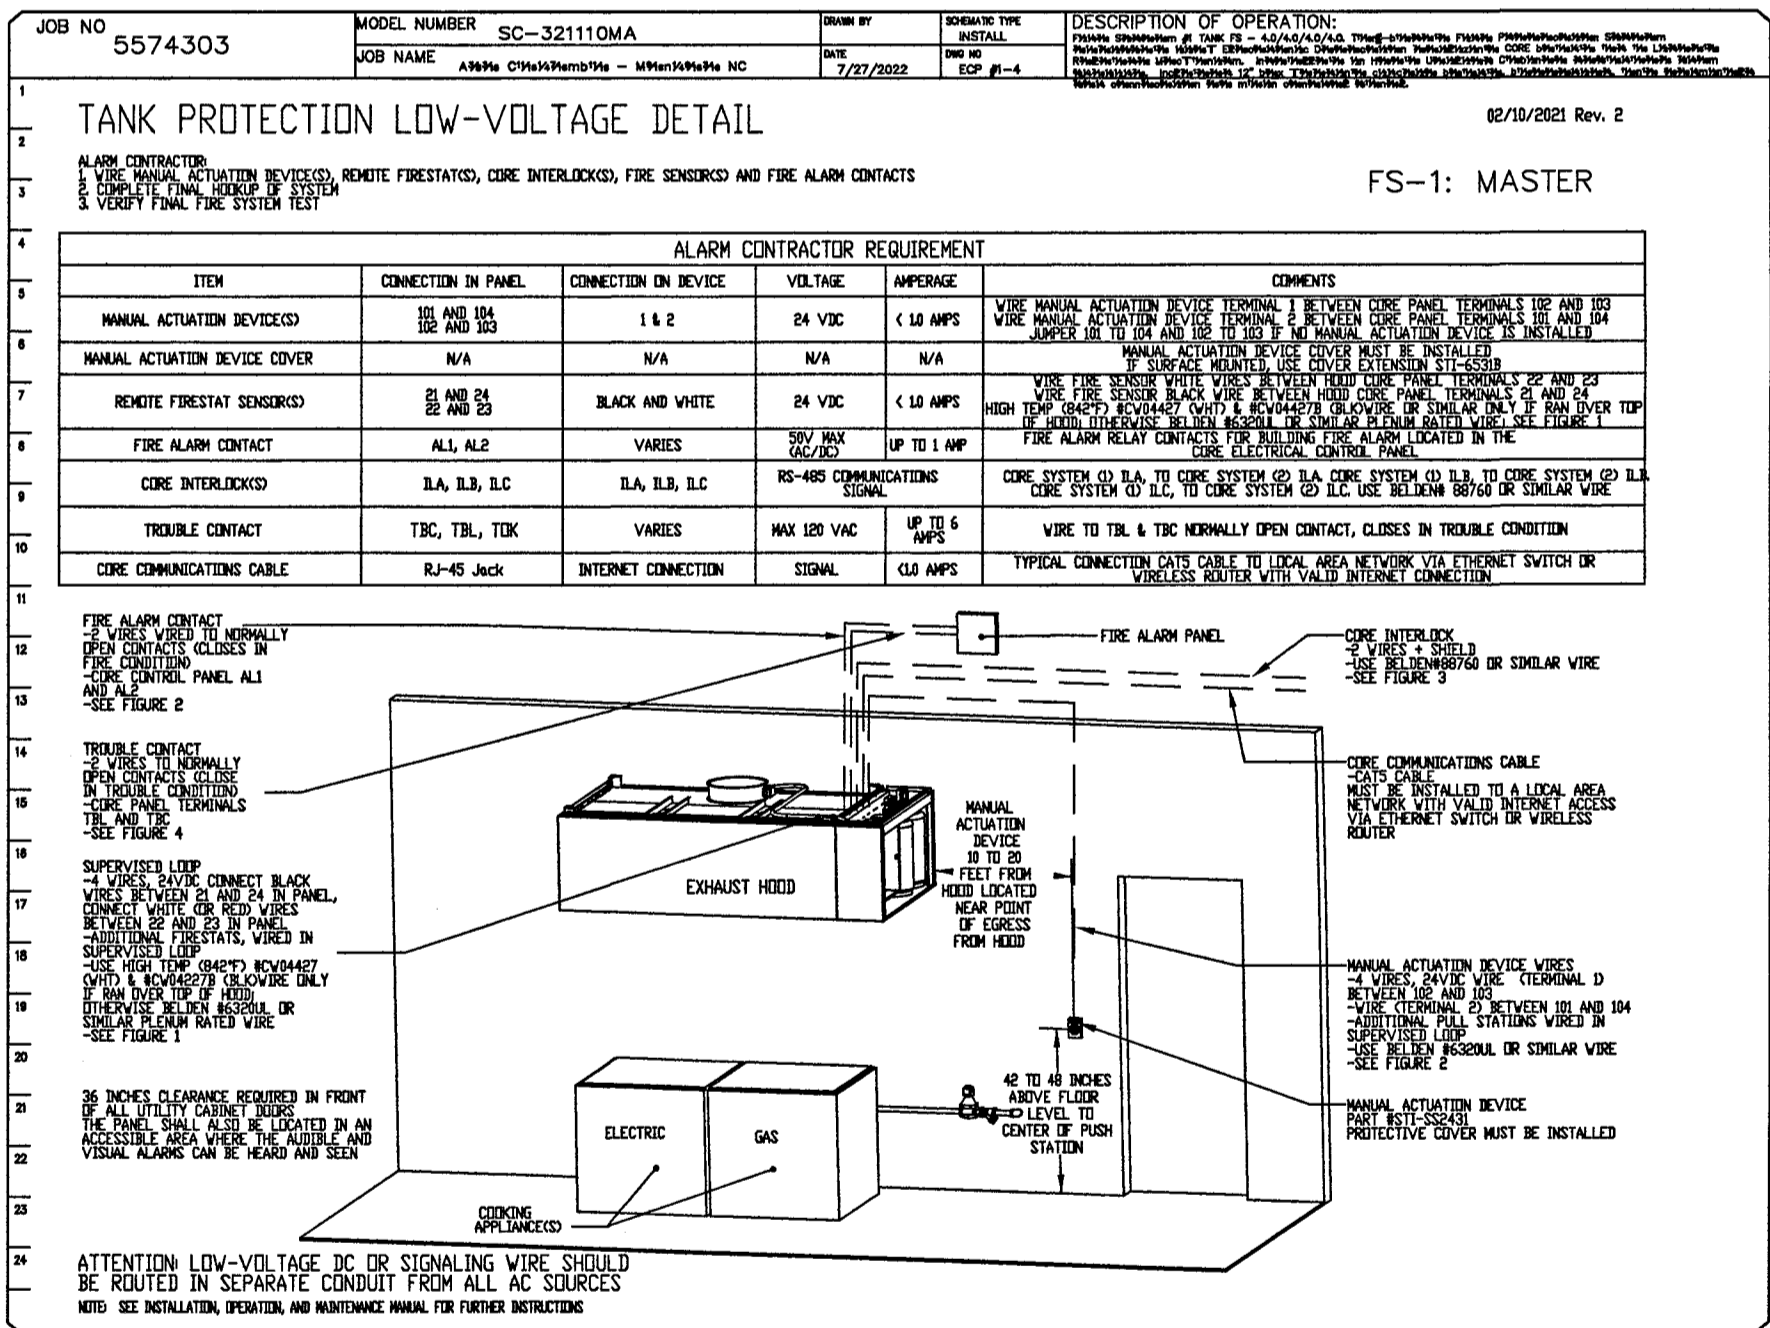
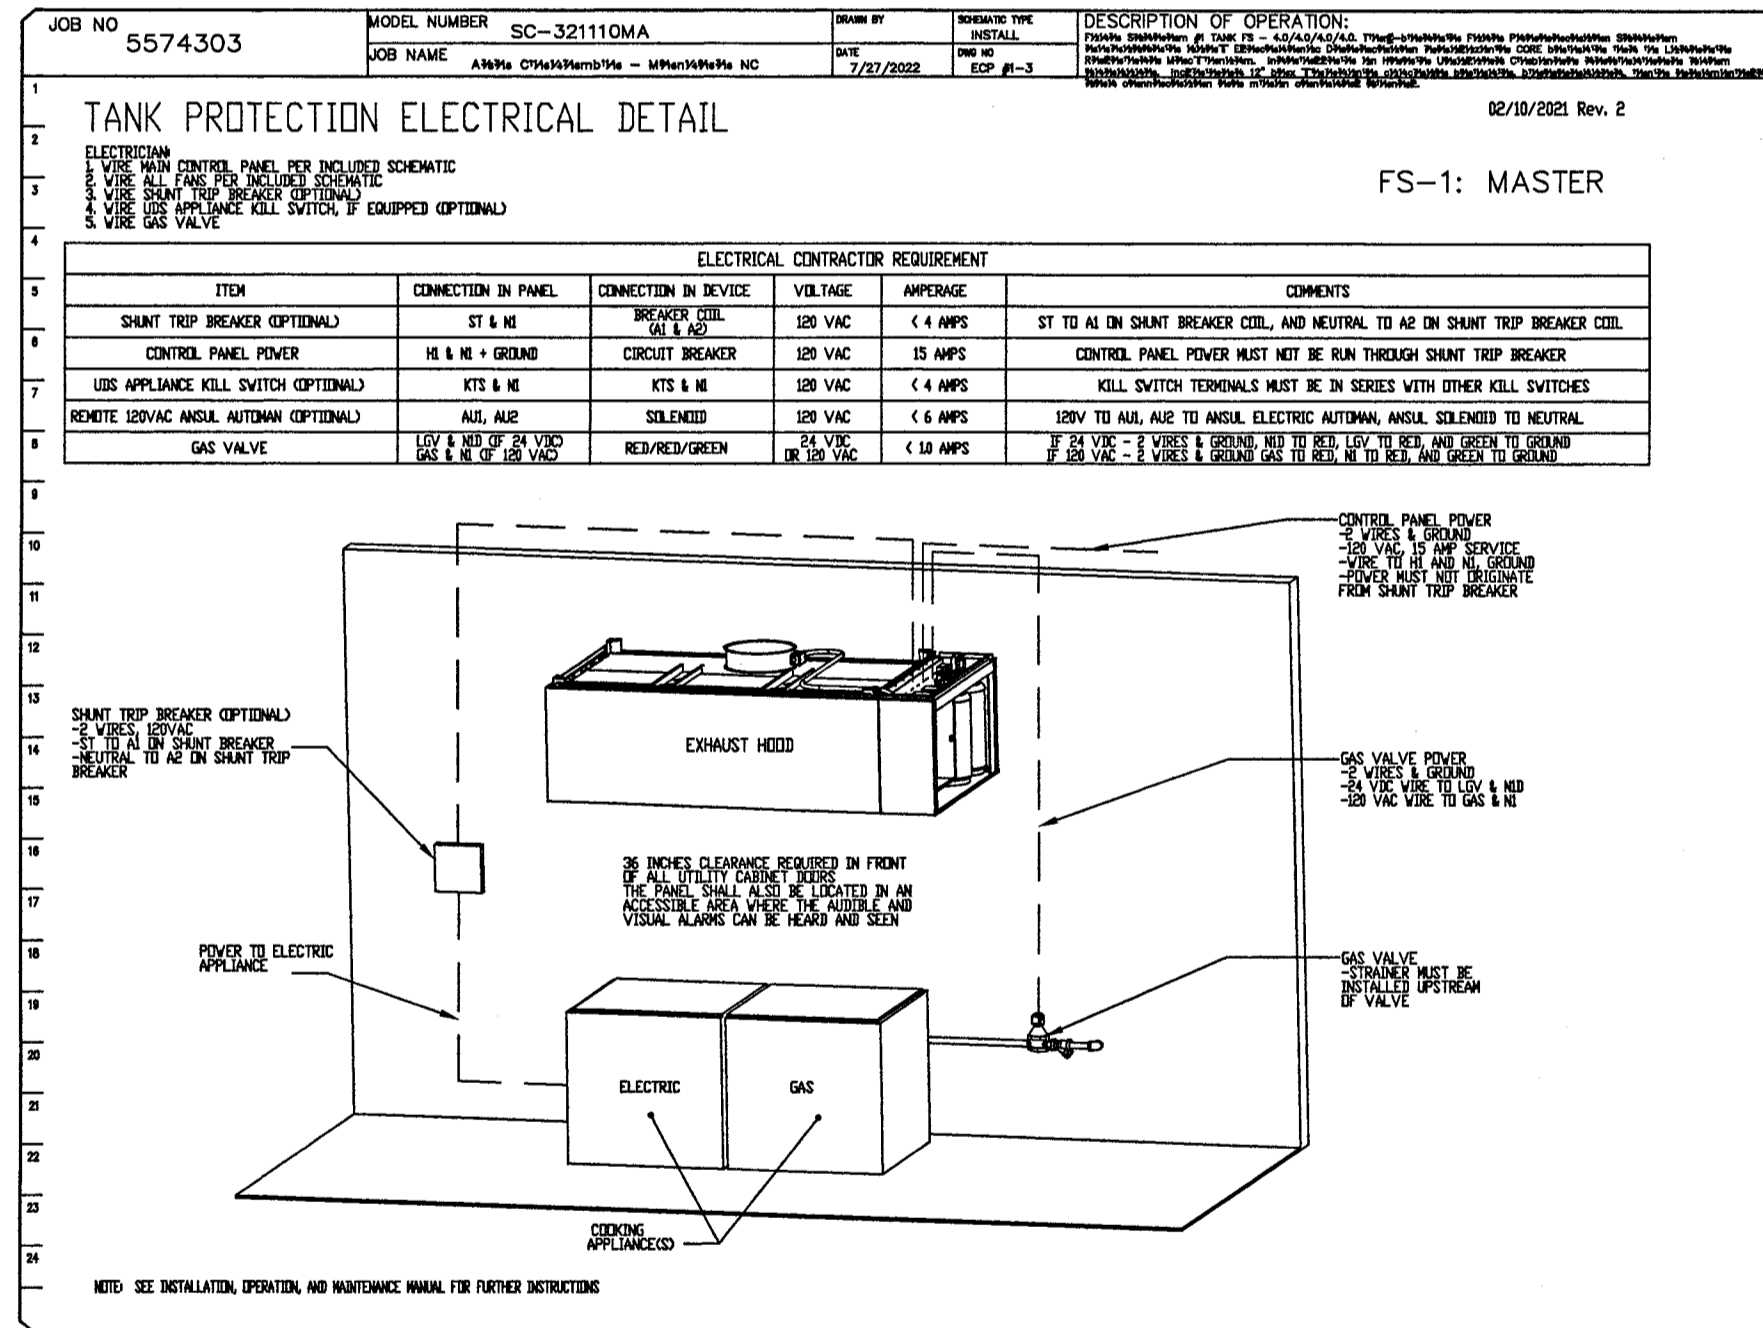
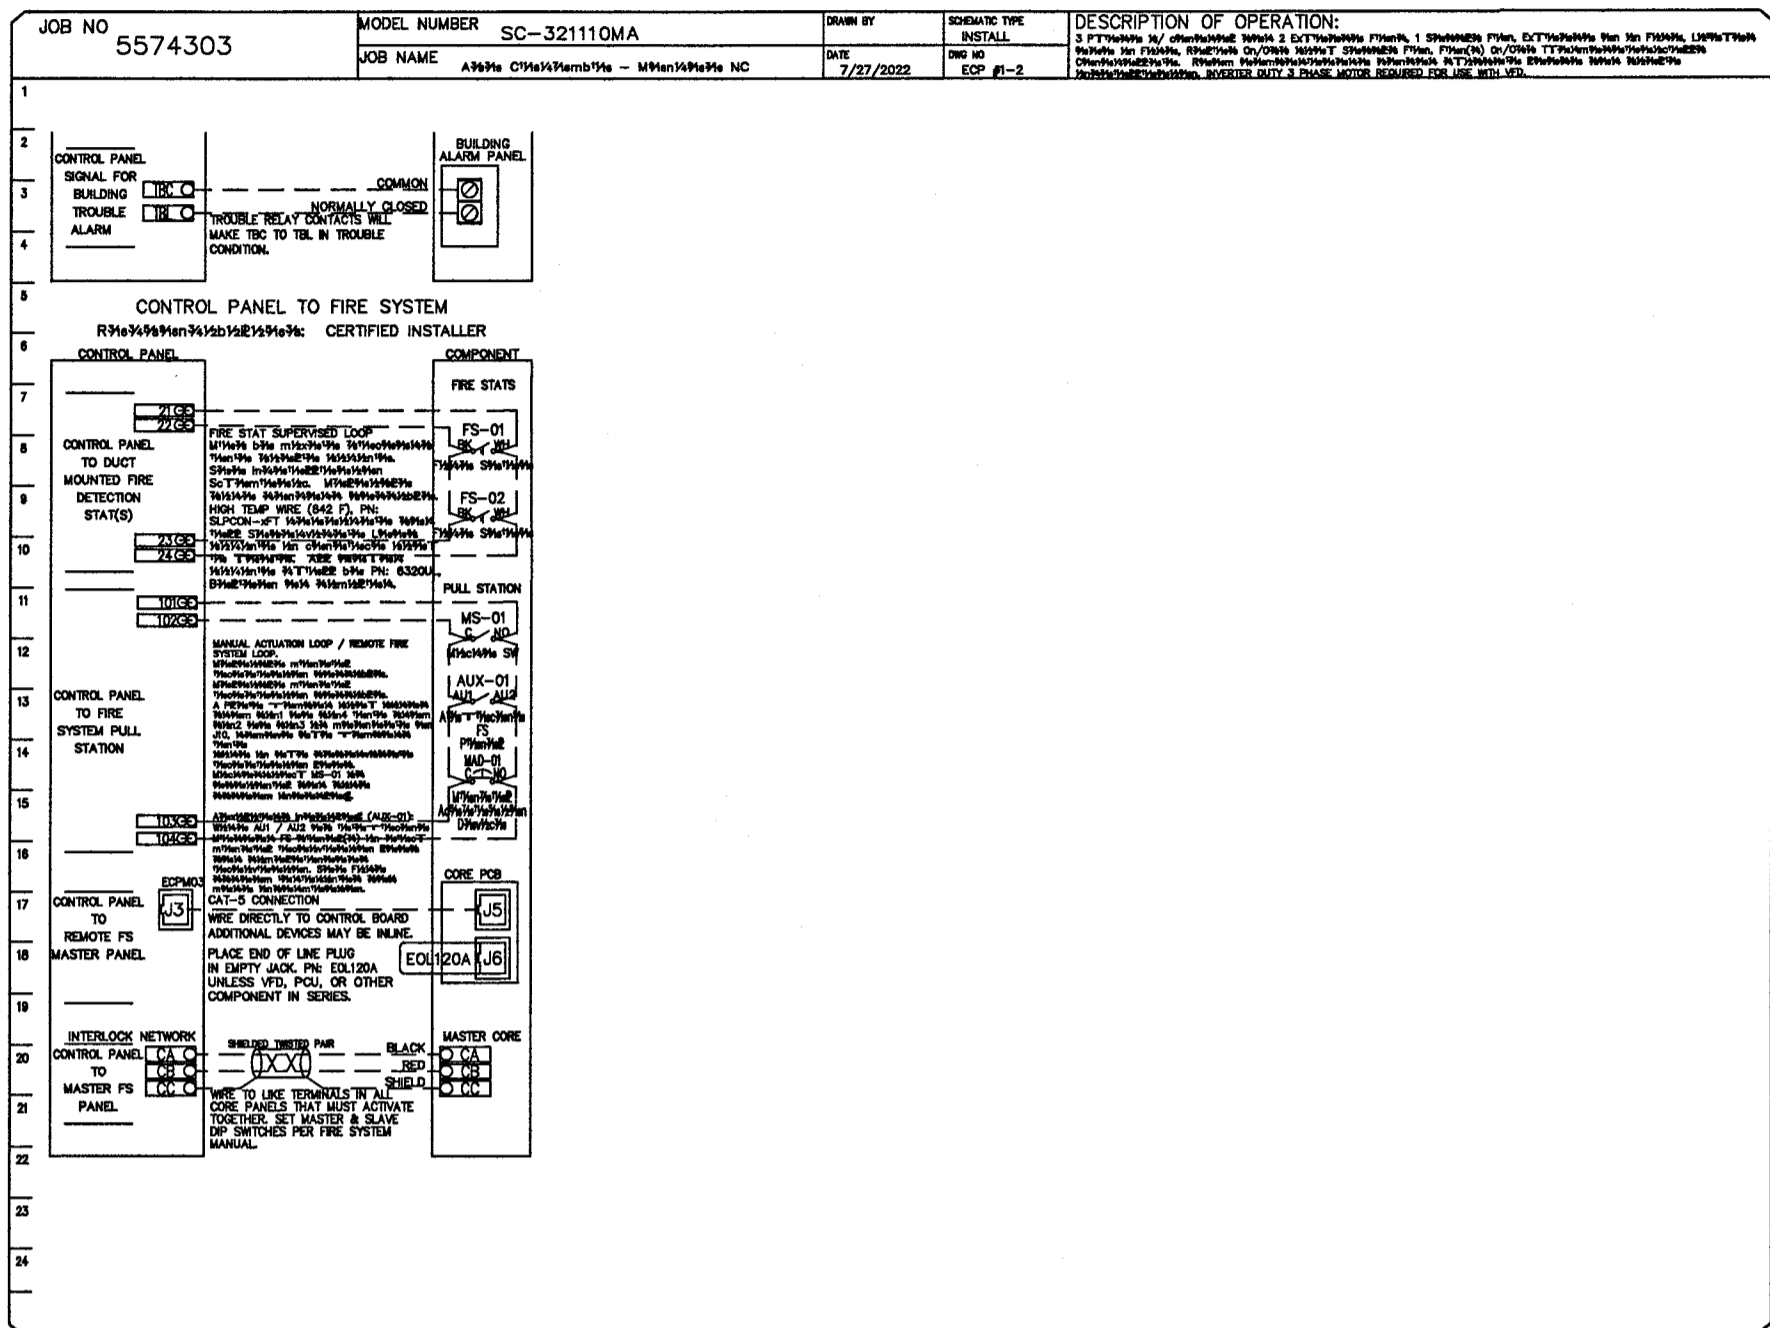
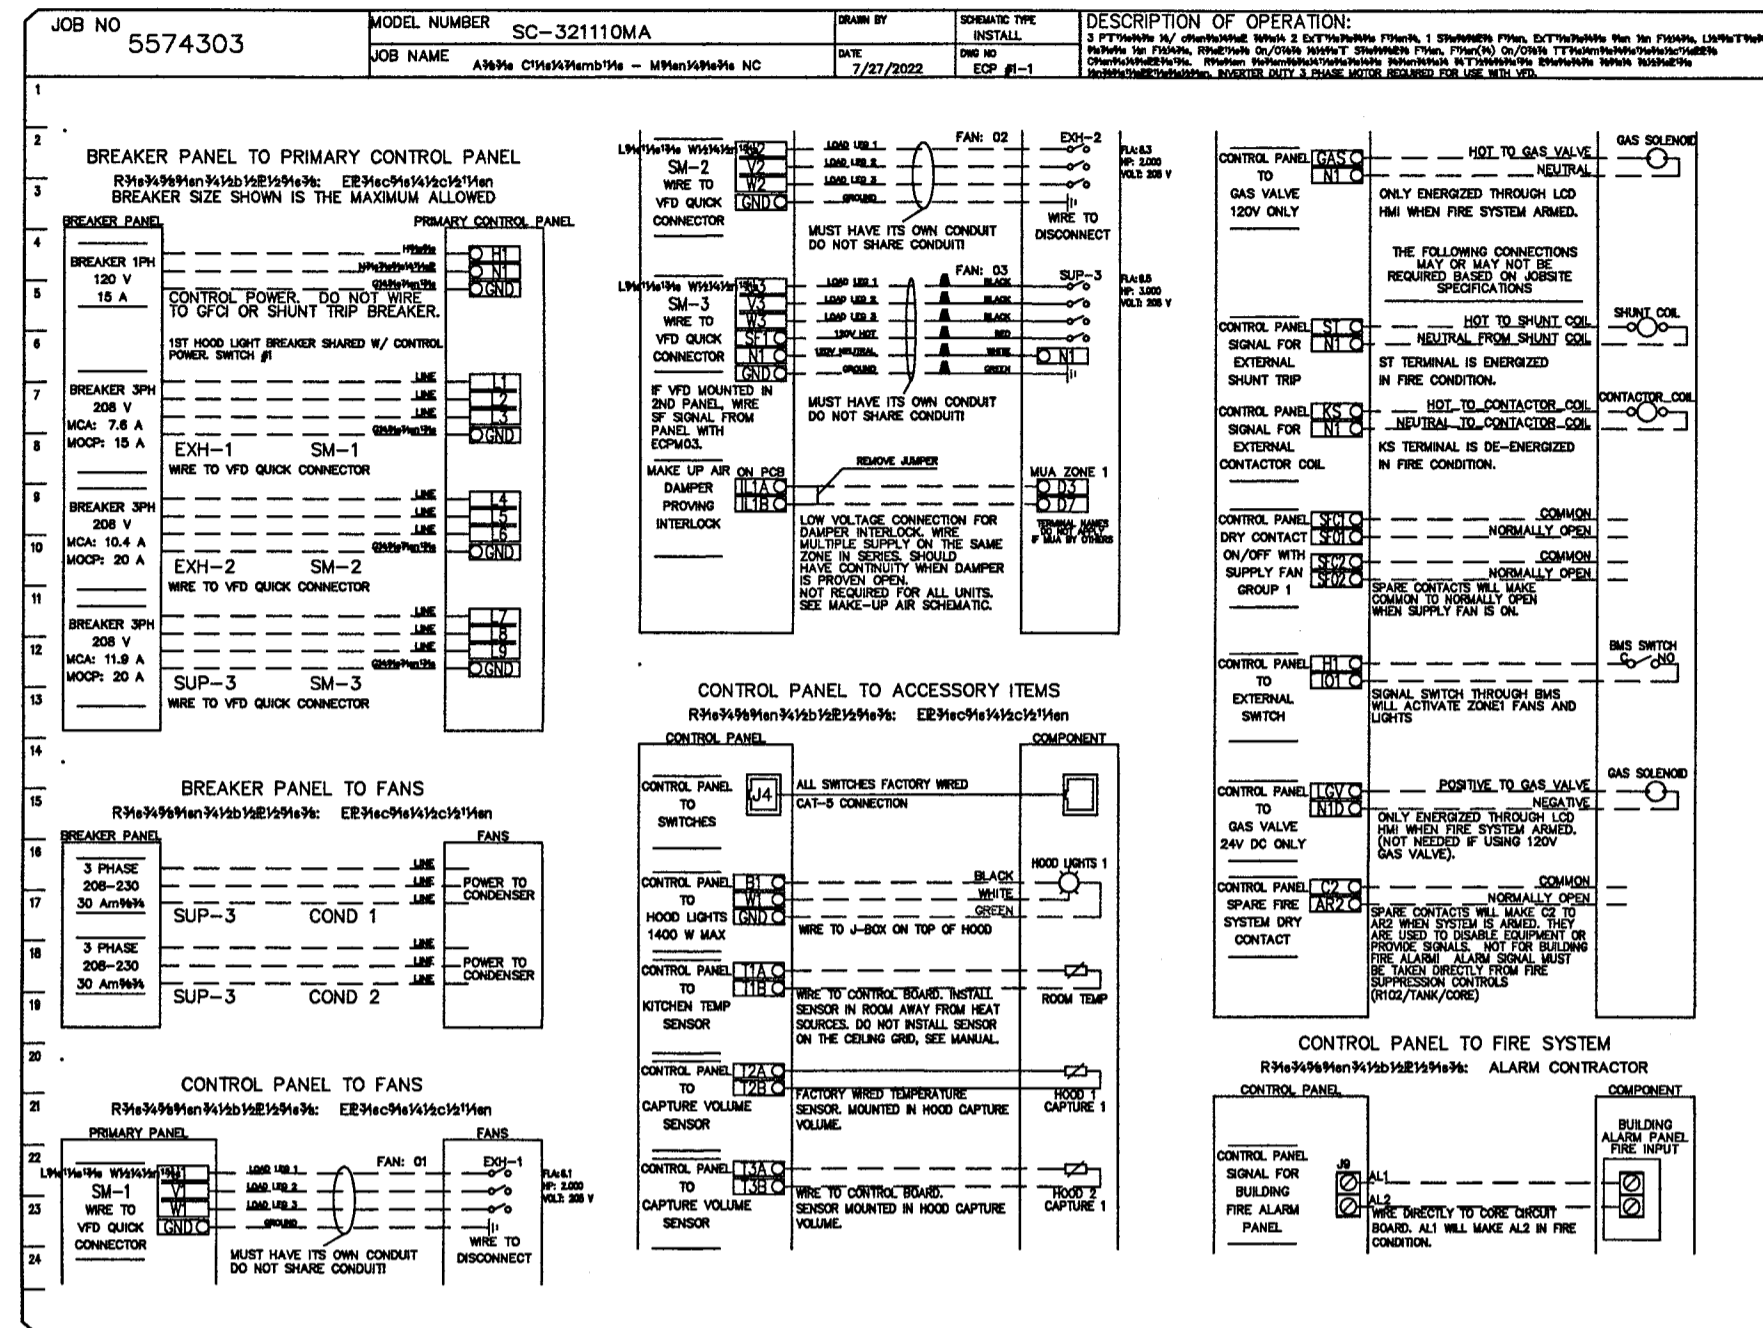
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**KITCHEN HOOD
 INFORMATION**

M3.5

ELECTRICAL PACKAGE - JOB#5574303										
NO	TAC	PACKAGE #	LOCATION	SWITCHES		OPTION	FANS CONTROLLED			
				LOCATION	QUANTITY		TYPE	HP	VOLT	FLA
1		SC-32111OMA	UTILITY CABINET LEFT	03 - UTILITY CABINET LEFT	1 LIGHT	SMART CONTROLS THERMOSTATIC CONTROL W/ RELAY ON/OFF WITH SUPPLY	EXHAUST 3	2,000	208	6.1
				HOOD # 1	1 FAN		EXHAUST 3	2,000	208	8.3
							SUPPLY 3	3,000	208	9.5



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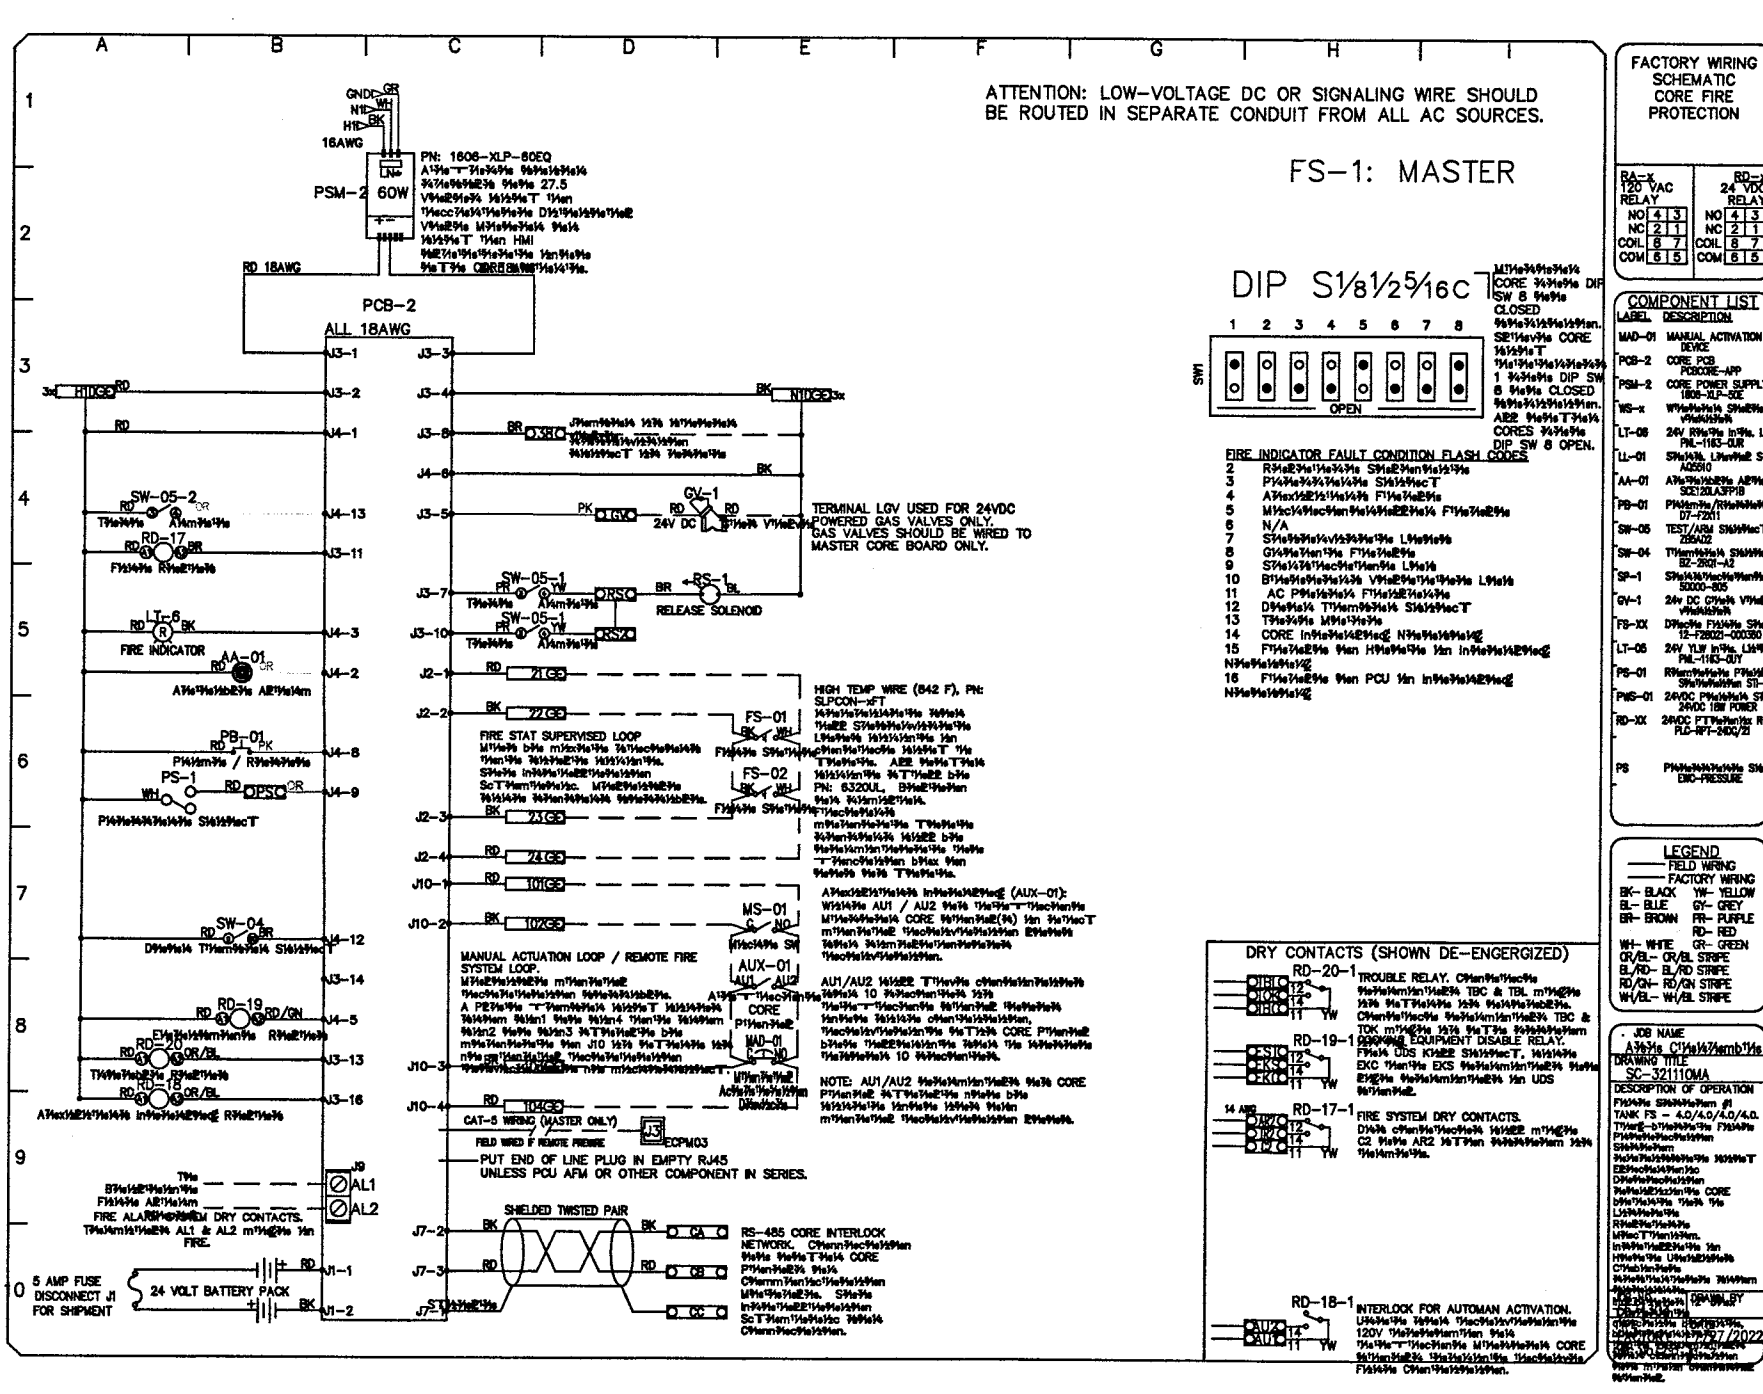
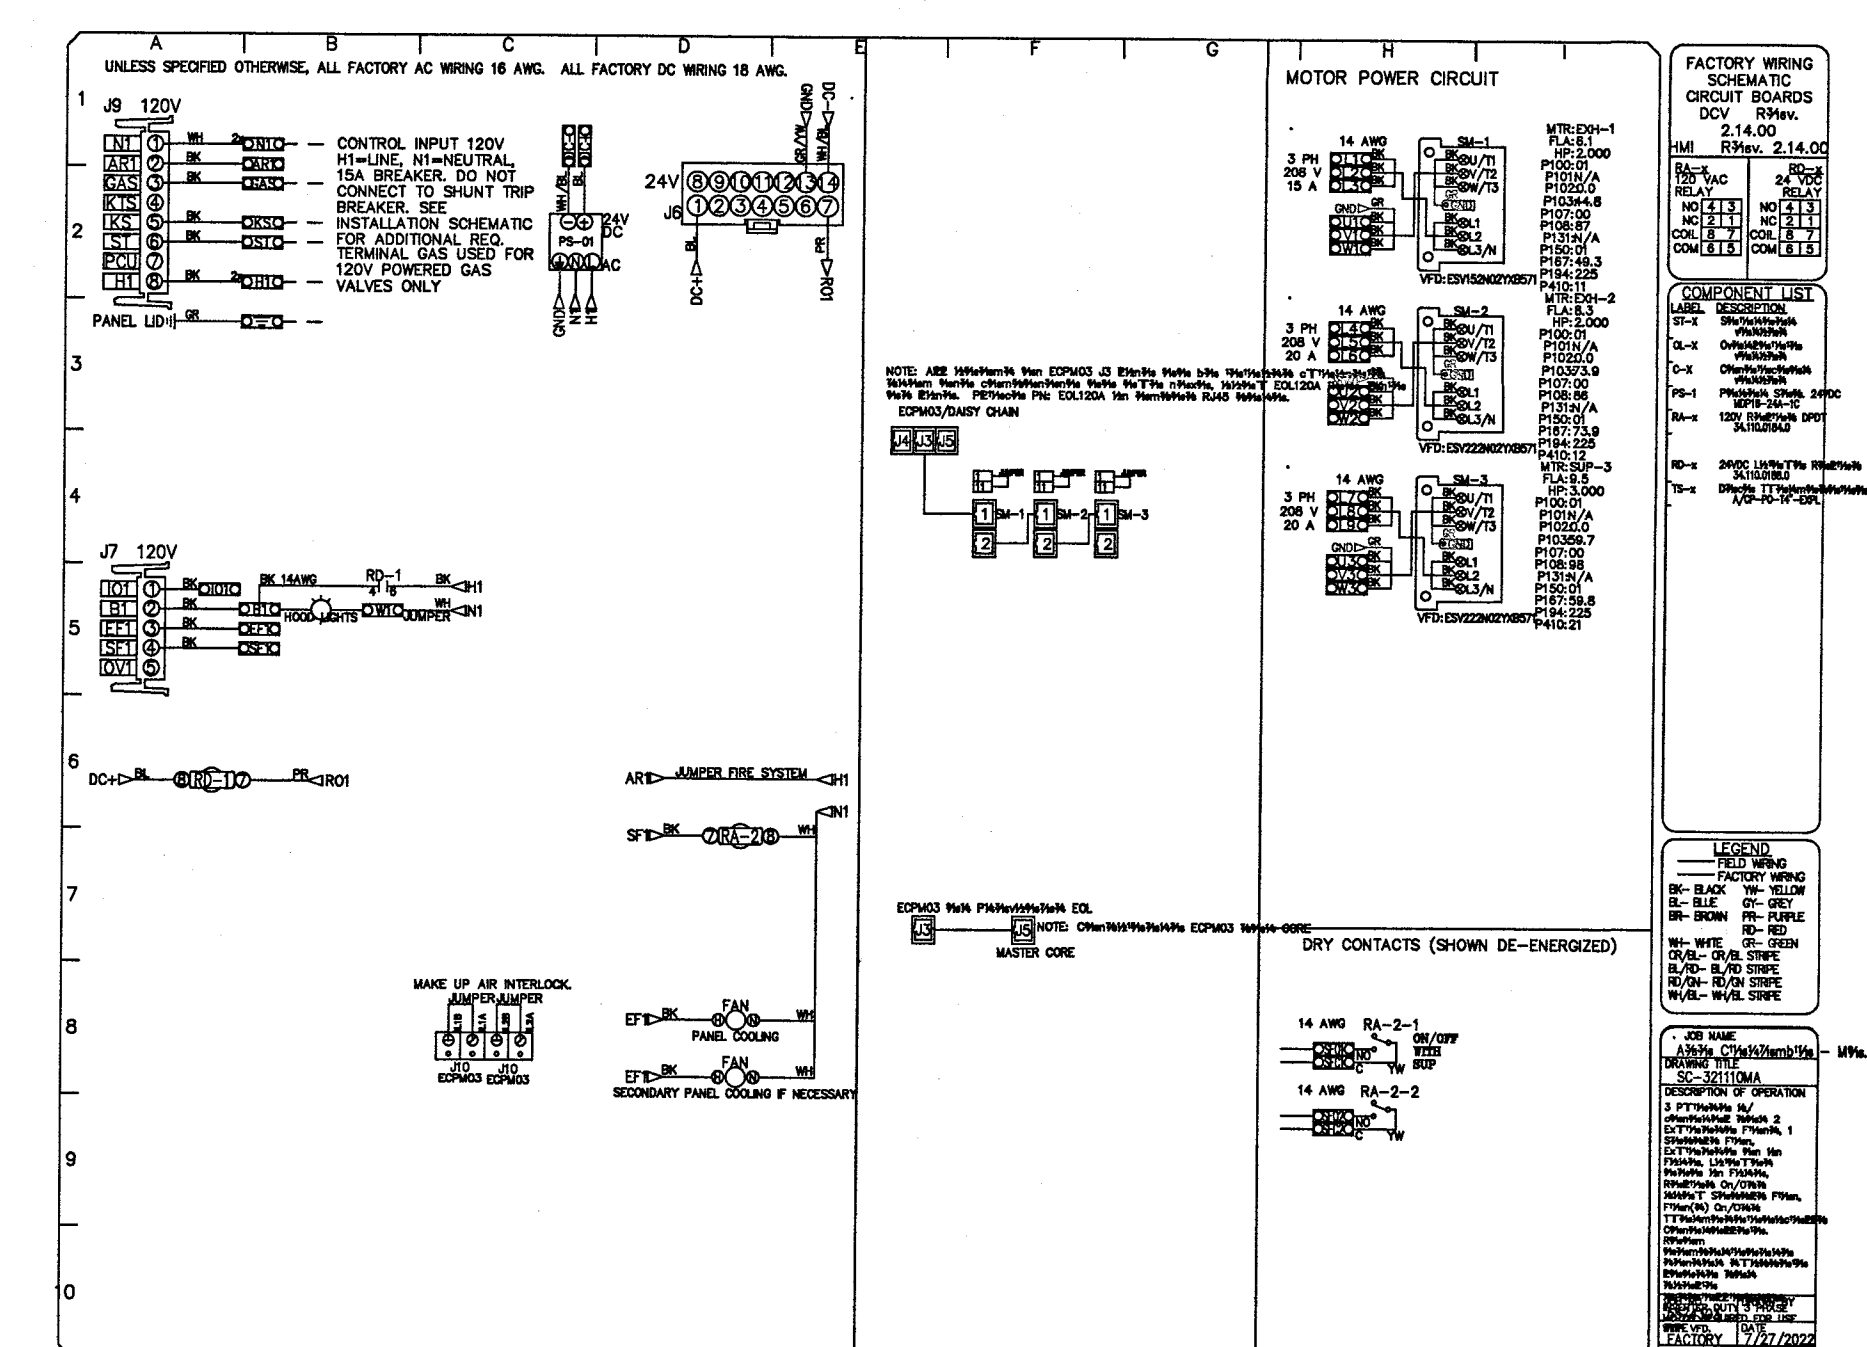
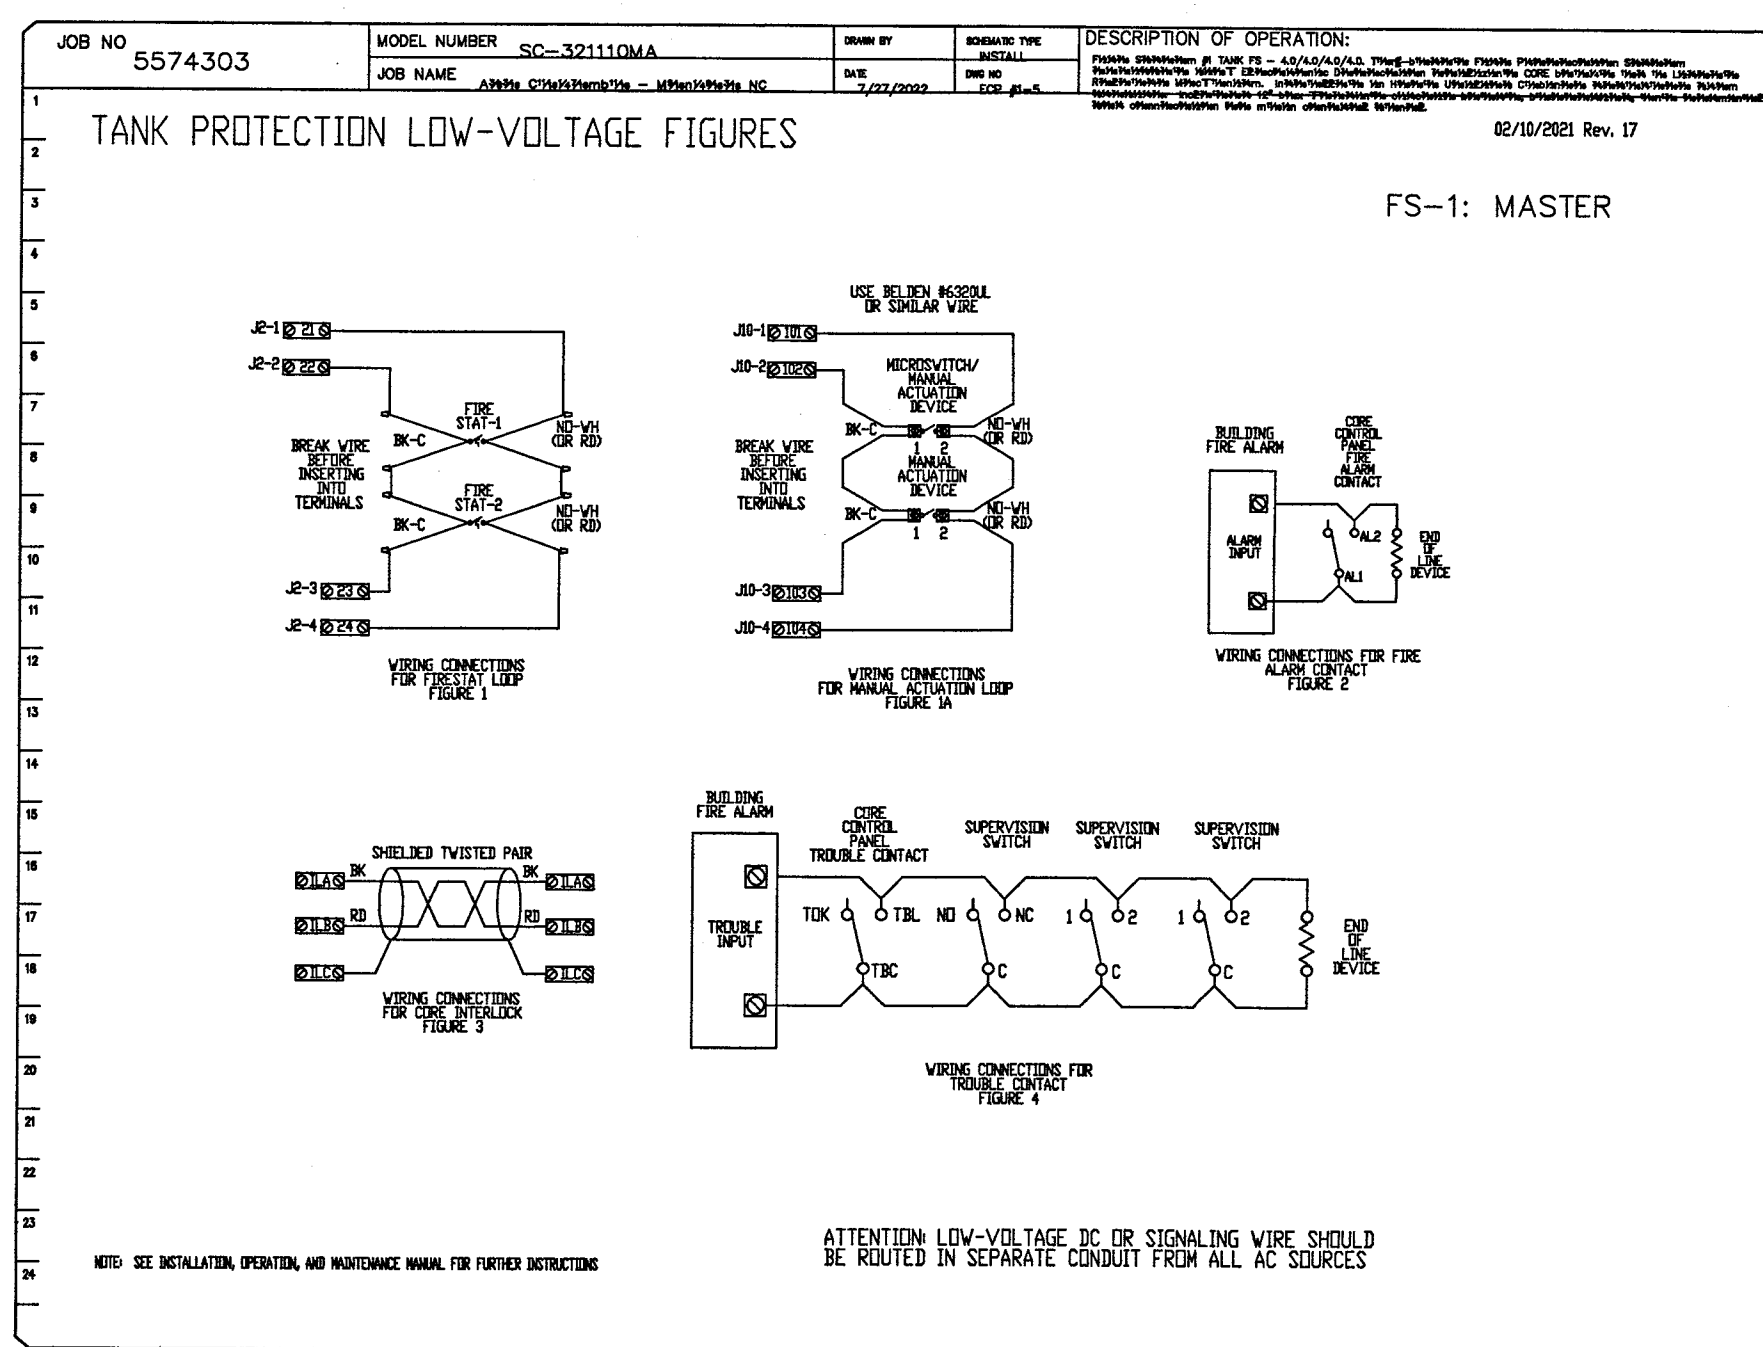
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KITCHEN HOOD INFORMATION

M3.6



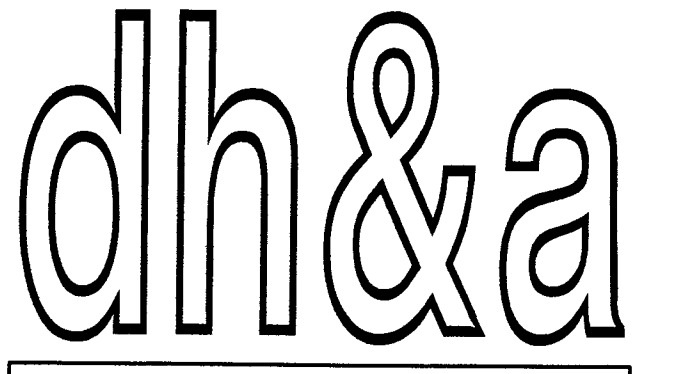
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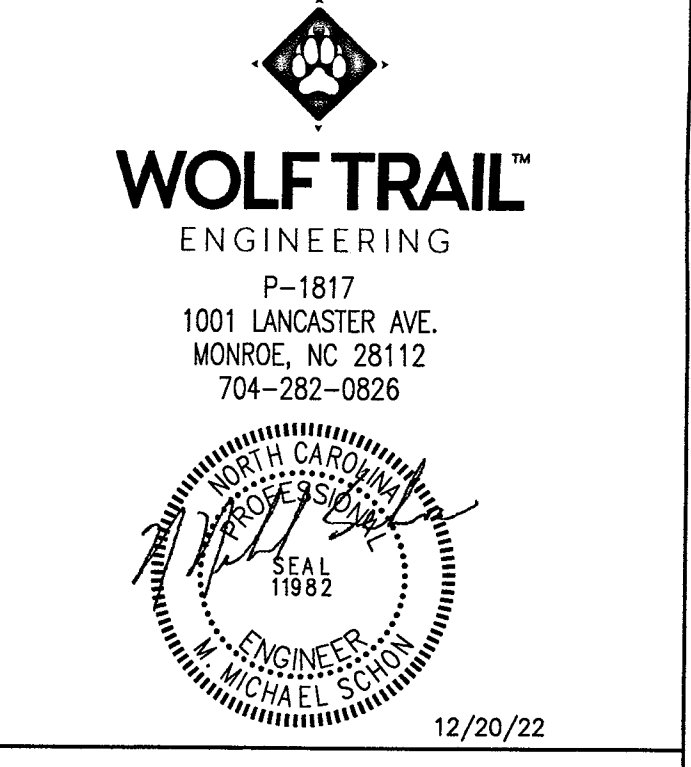
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KITCHEN HOOD
 INFORMATION

M3.7